Vanguard Community Development Office

2817 E Grand Blvd, Detroit MI 48211



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PROJECT DESCRIPTION

SCOPE OF WORK INCLUDES RENOVATION OF A FORMER OFFICE BUILDING INTO OFFICE SPACES. THIS BUILDING IS APPROXIMATELY 9,000 GROSS SQUARE FOOTAGE. THE MAJORITY OF WORK IS ON THE 2ND FLOOR. NEW MECHANICAL, PLUMBING AND ELECTRICAL SYSTEMS ARE BEING PROPOSED, WITH ONE EXISTING FURNACE REMAINING. NEW PARTITIONS, DOORS, DUCTWORK, VENTILATION, EXHAUST, LIGHT FIXTURES, PLUMBING FIXTURES, AND APPLIANCES ARE BEING PROVIDED. NO EXTERIOR FACADE RENOVATIONS ARE BEING PROPOSED.

DEFINED SUBMITTALS

ALL ENGINEERED DRAWINGS ARE TO BE SUBMITTED TO ARCHITECT FOR APROVAL PRIOR TO COMMENCEMENT OF WORK.

ELECTRICAL DRAWINGS PLUMBING DRAWINGS FIRE ALARM DRAWINGS

VOLUME I OF I

ISSUED FOR: CONSTRUCTION DOCUMENTS

ISSUE DATE: Issue Date 2407

Other Work

architecture advocacy art 3303 Wesson St Detroit, Michigan 48210 248.991.1457 laura@other-work.com

CLIENT:

Pamela Turner

pmturner@vanguardcdc.org 313.872.7831



LOCATION MAP

+ N



GENERAL NOTES

NOTIFY THE CITY OF NOVI CONSULTING ENGINEERS, MINIMUM OF 48 HOURS PRIOR TO THE START OF CONSTRUCTION CALL "MISS DIG" (800-482-7171) A MINIMUM OF 72 HOURS PRIOR TO THE START OF CONSTRUCTION.

ALL WORK SHALL CONFORM TO THE CURRENT CITY OF NOVI STANDARDS AND SPECIFICATIONS.

ALL EXCAVATION UNDER OR WITHIN 3 FEET OF PAVEMENT, EXISTING OR PROPOSED, OR WHERE SAND BACKFILL IS CALLED FOR ON THE PLAN, SHALL BE BACKFILLED AND COMPACTED WITH GRANULAR MATERIAL (SAND) MDOT CLASS II TO 95 PERCENT MAXIMUM UNIT DENSITY.

THE CONTRACTOR IS RESPONSIBLE FOR ALL DAMAGE TO EXISTING UTILITIES AND FACILITIES. ANY CONFLICTS WITH UTILITIES SHALL BE IMMEDIATELY REPORTED TO THE PROJECT ENGINEER.

DUST CONTROL SHALL BE MAINTAINED AT ALL TIMES.
ANY MUD TRACKED ONTO ROADS SHALL BE REMOVED DAILY.

THE FOLLOWING PROJECT GENERAL NOTES APPLY TO THE ENTIRE DRAWING SET AND ARE NOT SPECIFIC TO ANY ONE DISCIPLINE, UNLESS OTHERWISE NOTED:

DO NOT DISTRIBUTE OR UTILIZE PARTIAL DRAWINGS SETS.

UNLESS INDICATED OTHERWISE, THE 'ARCHITECTURAL' SERIES DRAWINGS TAKE PRECEDENCE FOR THE FINISHED APPEARANCE AND LOCATION OF ALL EXPOSED ELEMENTS OF THE WORK OF ALL TRADES, INCLUDING THAT WORK WHICH IS ILLUSTRATED PRIMARILY ON DRAWINGS OF OTHER DISCIPLINES.

THE DRAWINGS MAY MAKE REFERENCE TO OR ILLUSTRATE ITEMS WHICH ARE NOT PART OF THE WORK OF THE CONTRACT. THESE "NOT IN CONTRACT" ITEMS AS INDICATED ARE REFERENCED OR ILLUSTRATED FOR THE CONTRACTOR'S REFERENCE, INFORMATION AND COORDINATION ONLY.

VERIFY ACTUAL EXISTING CONDITIONS AT THE SITE PRIOR TO SUBMITTING A BID. NOTIFY THE ARCHITECT, IN WRITING AND PRIOR TO SUBMITTING A BID, OF ANY DISCREPANCIES. TAKE PRECAUTIONS TO MAINTAIN AND PROTECT NEW WORK AS WELL AS EXISTING SYSTEMS AND ELEMENTS, IF ANY, WHICH ARE TO REMAIN OR BE SALVAGED.

ALL PARTS OF THE WORK, INCLUDING BUT NOT LIMITED TO MATERIALS, METHODS, OR ASSEMBLIES, MUST COMPLY WITH THE REQUIREMENTS OF THE GOVERNING CODES AND REGULATIONS OF ALL FEDERAL, STATE AND LOCAL AUTHORITIES HAVING JURISDICTION OVER THE PROJECT, AS WELL AS THOSE GREATER REQUIREMENTS INDICATED BY THE CONTRACT DOCUMENTS. NO PART OF THE CONTRACT DOCUMENTS MAY BE CONSTRUED TO REQUIRE OR ALLOW WORK CONTRARY TO A GOVERNING CODE OR REGULATION.

IDENTIFY AND NOTIFY THE ARCHITECT OF CONFLICTS BETWEEN THE WORK OF DIFFERENT PARTIES AT THE EARLIEST POSSIBLE DATE SO AS TO ALLOW REASONABLE AND ADEQUATE TIME FOR THE CONFLICT TO BE RESOLVED WITHOUT DELAYING THE WORK. ALL DEVIATIONS FROM THE CONTRACT DOCUMENTS MUST BE APPROVED IN ADVANCE BY THE ARCHITECT AND OWNER.

REVIEW AND COORDINATE THE WORK OF ALL OTHER PARTIES PERFORMING WORK AT THE PROJECT, INCLUDING BUT NOT LIMITED TO, DELEGATED DESIGN ENTITIES, TRADES AND SUPPLIERS WITH THE REQUIREMENTS OF THE CONTRACT DOCUMENTS BEFORE COMMENCING CONSTRUCTION, AND ASSURE THAT ALL PARTIES ARE AWARE OF ALL REQUIREMENTS, REGARDLESS OF WHERE THE REQUIREMENTS OCCUR IN THE CONTRACT DOCUMENTS, WHICH MIGHT AFFECT THE WORK OF THAT PARTY.

DEMOLITION NOTES

REMOVE WALLS, DOORS, FRAMES, & ELECTRICAL AS INDICATED ON PLAN. TELEPHONE OUTLETS & ELECTRICAL WITHIN WALLS TO BE DEMOLISHED SHALL BE REMOVED AND/OR CAPPED. REMOVE WIRE, CONDUIT AND/OR CABLE BACK TO SOURCE (PHONE BOARD OR ELECTRICAL PANEL). ALL MATERIALS FROM DEMOLITION SHALL BE DISPOSED OF IN ACCORDANCE WITH CITY, STATE, & FEDERAL REGULATION, UNLESS INDICATED TO BE SALVAGED. PATCH AND REPAIR EXISTING GYPSUM BOARD FINISH AS REQUIRED.

DEMOLITION WORK SHALL BE DONE IN A MANNER WHICH WILL NOT CAUSE UNNECESSARY INCONVIENIENCE OR DANGER TO USERS OF THE PREMISES AND ADJACENT SITE AND NOT INTERFERE WITH ITS OPERATION. ANY DEMOLITION WORK TO BE PERFORMED MUST BE PLANNED IN ADVANCE AND APPROVED BY THE OWNER.

ANY EQUIPMENT, MATERIALS, AND SUPPLIES TEMPORARILY REMOVED FOR THE PURPOSE OF PROTECTION SHALL BE REPLACED IN ORIGINAL LOCATIONS AND CONDITIONS. ANY MATERIALS DAMAGED SHALL BE REPLACED WITH NEW MATERIALS OF LIKE KIND AND QUALITY.

ALL MATERIALS INDICATED TO BE REMOVED SHALL BE DISPOSED OF PROPERLY AND REMOVED FROM THE SITE. CONTRACTOR SHALL BE RESPONSIBLE FOR REMOVAL AND DISPOSAL OF ALL TRASH AND DEBRIS FROM THE PROJECT SITE.

CONTRACTOR SHALL BE RESPONSIBLE FOR SECURING THE SITE AGAINST VANDALS AND THEFT

ALL REMOVED MATERIALS AND EQUIPMENT WHICH IS CLASSIFIED AS "SALVAGE FOR OWNER" SHALL REMAIN THE PROPERTY OF THE OWNER. DELIVER SUCH MATERIALS AND EQUIPMENT ON THE PREMISES AS DIRECTED BY THE OWNER AND NEATLY STORE AND PROTECT FROM DAMAGE.

PATCH AND REPAIR ALL ELEMENTS THAT ARE TO REMAIN WHICH ARE DAMAGED FROM THE DEMOLITION WORK WITH CONSTRUCTION TO MATCH EXISTING CONDITIONS.

ARCHITECTURAL NOTES

DO NOT SCALE DRAWINGS.

ALL DIMENSIONS SHALL BE VERIFIED BY THE CONTRACTOR PRIOR TO CONSTRUCTION. ANY DISCREPANCIES SHALL BE REPORTED TO THE ARCHITECT IMMEDIATELY.

CONTRACTOR SHALL PROVIDE ALL ITEMS, ARTICLES, MATERIALS, AND OPERATIONS SCHEDULED INCLUDING ALL LABOR, MATERIALS, AND INCIDENTALS REQUIRED FOR COMPLETION.

ALL CONSTRUCTION SHALL CONFORM TO ALL APPLICABLE LOCAL STATE, AND FEDERAL CODES AND LAWS

THE TERM "TYPICAL" SHALL DENOTE THE SAME OR SIMILAR MANNER OF WORK AND MATERIALS AS DESIGNATED THROUGHOUT THE CONTRACT CONSTRUCTION DRAWINGS AND AS DESCRIBED BY THE PROJECT SPECIFICATIONS IN APPROPRIATE AREAS.

THE CONTRACTOR AND/OR BUILDER WILL ASSUME RESPONSIBILITY OF MAKING ANY CHANGES IN THE CONSTRUCTION PLANS, DRAWINGS, DETAILS, AND SPECIFICATION, AS MAY BE NEEDED, TO ADJUST FOR LOCAL CODE REQUIREMENTS AND CONDITIONS.

CONTRACTOR SHALL BE RESPONSIBLE FOR OBTAINING ALL APPLICABLE BUILDING AND OTHER PERMITS REQUIRED FOR THE COMPLETION OF THE WORK.

THE ARCHITECTURAL DRAWINGS ARE PART OF A LARGER SET OF DRAWINGS WHICH, WHEN COMPLETE, CONSISTS OF ALL REQUIRED DRAWINGS FOR THE EXECUTION OF WORK. THE WORK DESCRIBED BY THE DRAWINGS OF ANY ONE DISCIPLINE MAY BE AFFECTED BY THE WORK DESCRIBED ON DRAWINGS OF ANOTHER DISCIPLINE AND MAY REQUIRE REFERENCE TO THE DRAWINGS OF ANOTHER DISCIPLINE. PARTIAL SETS OF DRAWINGS ARE INCOMPLETE AND SHOULD NOT BE DISTRIBUTED OR UTILIZED BY THE CONTRACTOR.

ARCHITECTURAL NOTES - CONTINUED

THE ARCHITECTURAL DRAWINGS ESTABLISH AND COORDINATE THE FINISHED APPEARANCE AND EXACT LOCATION OF ALL EXPOSED ELEMENTS OF THE WORK OF ALL THE TRADES, INCLUDING THAT WORK WHICH IS ILUSTRATED PRIMARILY ON DRAWINGS OF OTHER DISCIPLINES. LOCATIONS SHOWN ON OTHER DRAWINGS ARE SCHEMATIC, UNLESS OTHERWISE NOTED ON THE ARCHITECTURAL DRAWINGS. THE ARCHITECTURAL DRAWINGS TAKE PRECEDENCE FOR THE FINISHED APPEARANCE AND EXACT LOCATION OF ALL PARTS OF THE WORK.

REFER TO MECHANICAL, ELECTRICAL, AND PLUMBING DRAWINGS FOR DETAILED DESIGN OF THE MECHANICAL, ELECTRICAL AND PLUMBING SYSTEMS, OF WHICH PORTIONS MAY BE SHOWN ON THE ARCHITECTURAL DRAWINGS

EXCEPT WHERE DIRECTED TO PLACE ITEMS OF WORK AT THE APPROXIMATE LOCATIONS SHOWN, DO NOT SCALE DRAWINGS FOR DIMENSIONAL INFORMATION. ALL ELEMENTS OF THE DRAWINGS MAY NOT BE DRAWN TO EXACT SCALE. ALL DIMENSIONS REQUIRED ARE SHOWN OR MAY BE DERIVED FROM THOSE SHOWN ON THE FLOOR PLANS, DETAIL PLANS, ELEVATIONS, SECTIONS, DETAILS, SCHEDULES, AND SPECIFICATIONS.

CONTRACTOR SHALL VERIFY ALL DIMENSIONS AND CONDITIONS SHOWN ON THE DRAWINGS AT THE JOB SITE. NOTIFY THE ARCHITECT OR OWNER PRIOR TO COMMENCING WORK OF ANY DISCREPANCIES, CONFLICTS OR OMISSIONS IN THE CONSTRUCTION DOCUMENTS AND BETWEEN CONSTRUCTION DOCUMENTS AND FIELD CONDITIONS. AN ADDENDUM WILL BE ISSUED AS NECESSARY AND WILL BECOME A PART OF THE CONTRACT DOCUMENTS. FOR THOSE DISCREPANCIES NOT BROUGHT TO THE ATTENTION OF THE ARCHITECT OR OWNER, IT WILL BE ASSUMED THAT THE CONTRACTOR HAS BID THE MORE EXPENSIVE METHOD OF CONSTRUCTION.

ALL DIMENSION LUMBER, PLYWOOD, PARTICLE BD., FURRING AND BLOCKING SHALL BE PRESSURE TREATED / UL CERTIFIED NON-COMBUSTIBLE.

COORDINATE LOCATION OF BLOCKING WITHIN PARTITIONS FOR ITEMS TO BE SECURED TO SURFACE.

CONTRACTOR SHALL KEEP THE PREMISES FREE FROM ACCUMULATION OF WASTE MATERIALS AND DEBRIS AND PROVIDE FINAL CLEAN-UP OF JOB SITE PRIOR TO MOVE-IN.

CONTRACTOR TO PROVIDE ALL NECESSARY TEMPORARY PROTECTION TO ENSURE THE SAFETY OF THE EXISTING TENANT AND GENERAL PUBLIC DURING CONSTRUCTION.

COORDINATE ALL WORK BEFORE AND DURING CONSTRUCTION WITH ALL OTHER AFFECTED TRADES.

WHERE INTERFERENCES DEVELOP, NOTIFY ARCHITECT FOR RESOLUTION OF CONFLICT.

RELOCATION OF CONFLICTING INSTALLED WORK, DUE TO LACK OF COORDINATION, OR POOR

COORDINATION WILL NOT BE CONSIDERED EXTRA WORK.

NO OPENINGS ON SLAB SHALL BE PROVIDED UNLESS APPROVED BY THE ARCHITECT.

ALL WINDOWS AND GLAZING WITHIN THE INTERIOR OF THE CLINIC SHALL BE TEMPERED SAFETY GLASS.

REFER TO SHEET A2.1 FOR REQUIREMENTS.

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architecture advocacy art

ISSUED FOR REV DATE

CONSTRUCTION DOCUMENTS 1 06NOV2024

SEAL & SIGNATURE



PROJECT VANGUARD OFFICES

2817 E GRAND BLVD DETROIT, MI 48211


GENERAL NOTES

PROJECT NORTH





		Area Schedule (LIFE SAFETY)			
Level	LS OCCUPANCY	LS Occupancy Class Name	Area	LOAD FACTOR	OCCUPANTS
Level 1	ASSEMBLY	ASSEMBLY - UNCONCENTRATED TABLES AND CHAIRS	326 SF	15	22
Level 1	BUSINESS	BUSINESS - OFFICE	2276 SF	100	23
Level 1	EDUCATIONAL	CLASSROOM	645 SF	20	33
Level 1	KITCHEN	BUSINESS - KITCHEN	380 SF	200	2
Level 1	STORAGE	MECHANICAL	85 SF	300	1
Level 1	STORAGE	STORAGE	48 SF	300	1
			3760 SF		82
LVL 02	ASSEMBLY	ASSEMBLY - UNCONCENTRATED TABLES AND CHAIRS	202 SF	15	14
LVL 02	BUSINESS	BUSINESS - OFFICE	2676 SF	100	27
LVL 02	BUSINESS	UNOCCUPIED	719 SF	0	0
LVL 02	STORAGE	MECHANICAL	53 SF	300	1
			3650 SF	1	42
			7410 SF		124

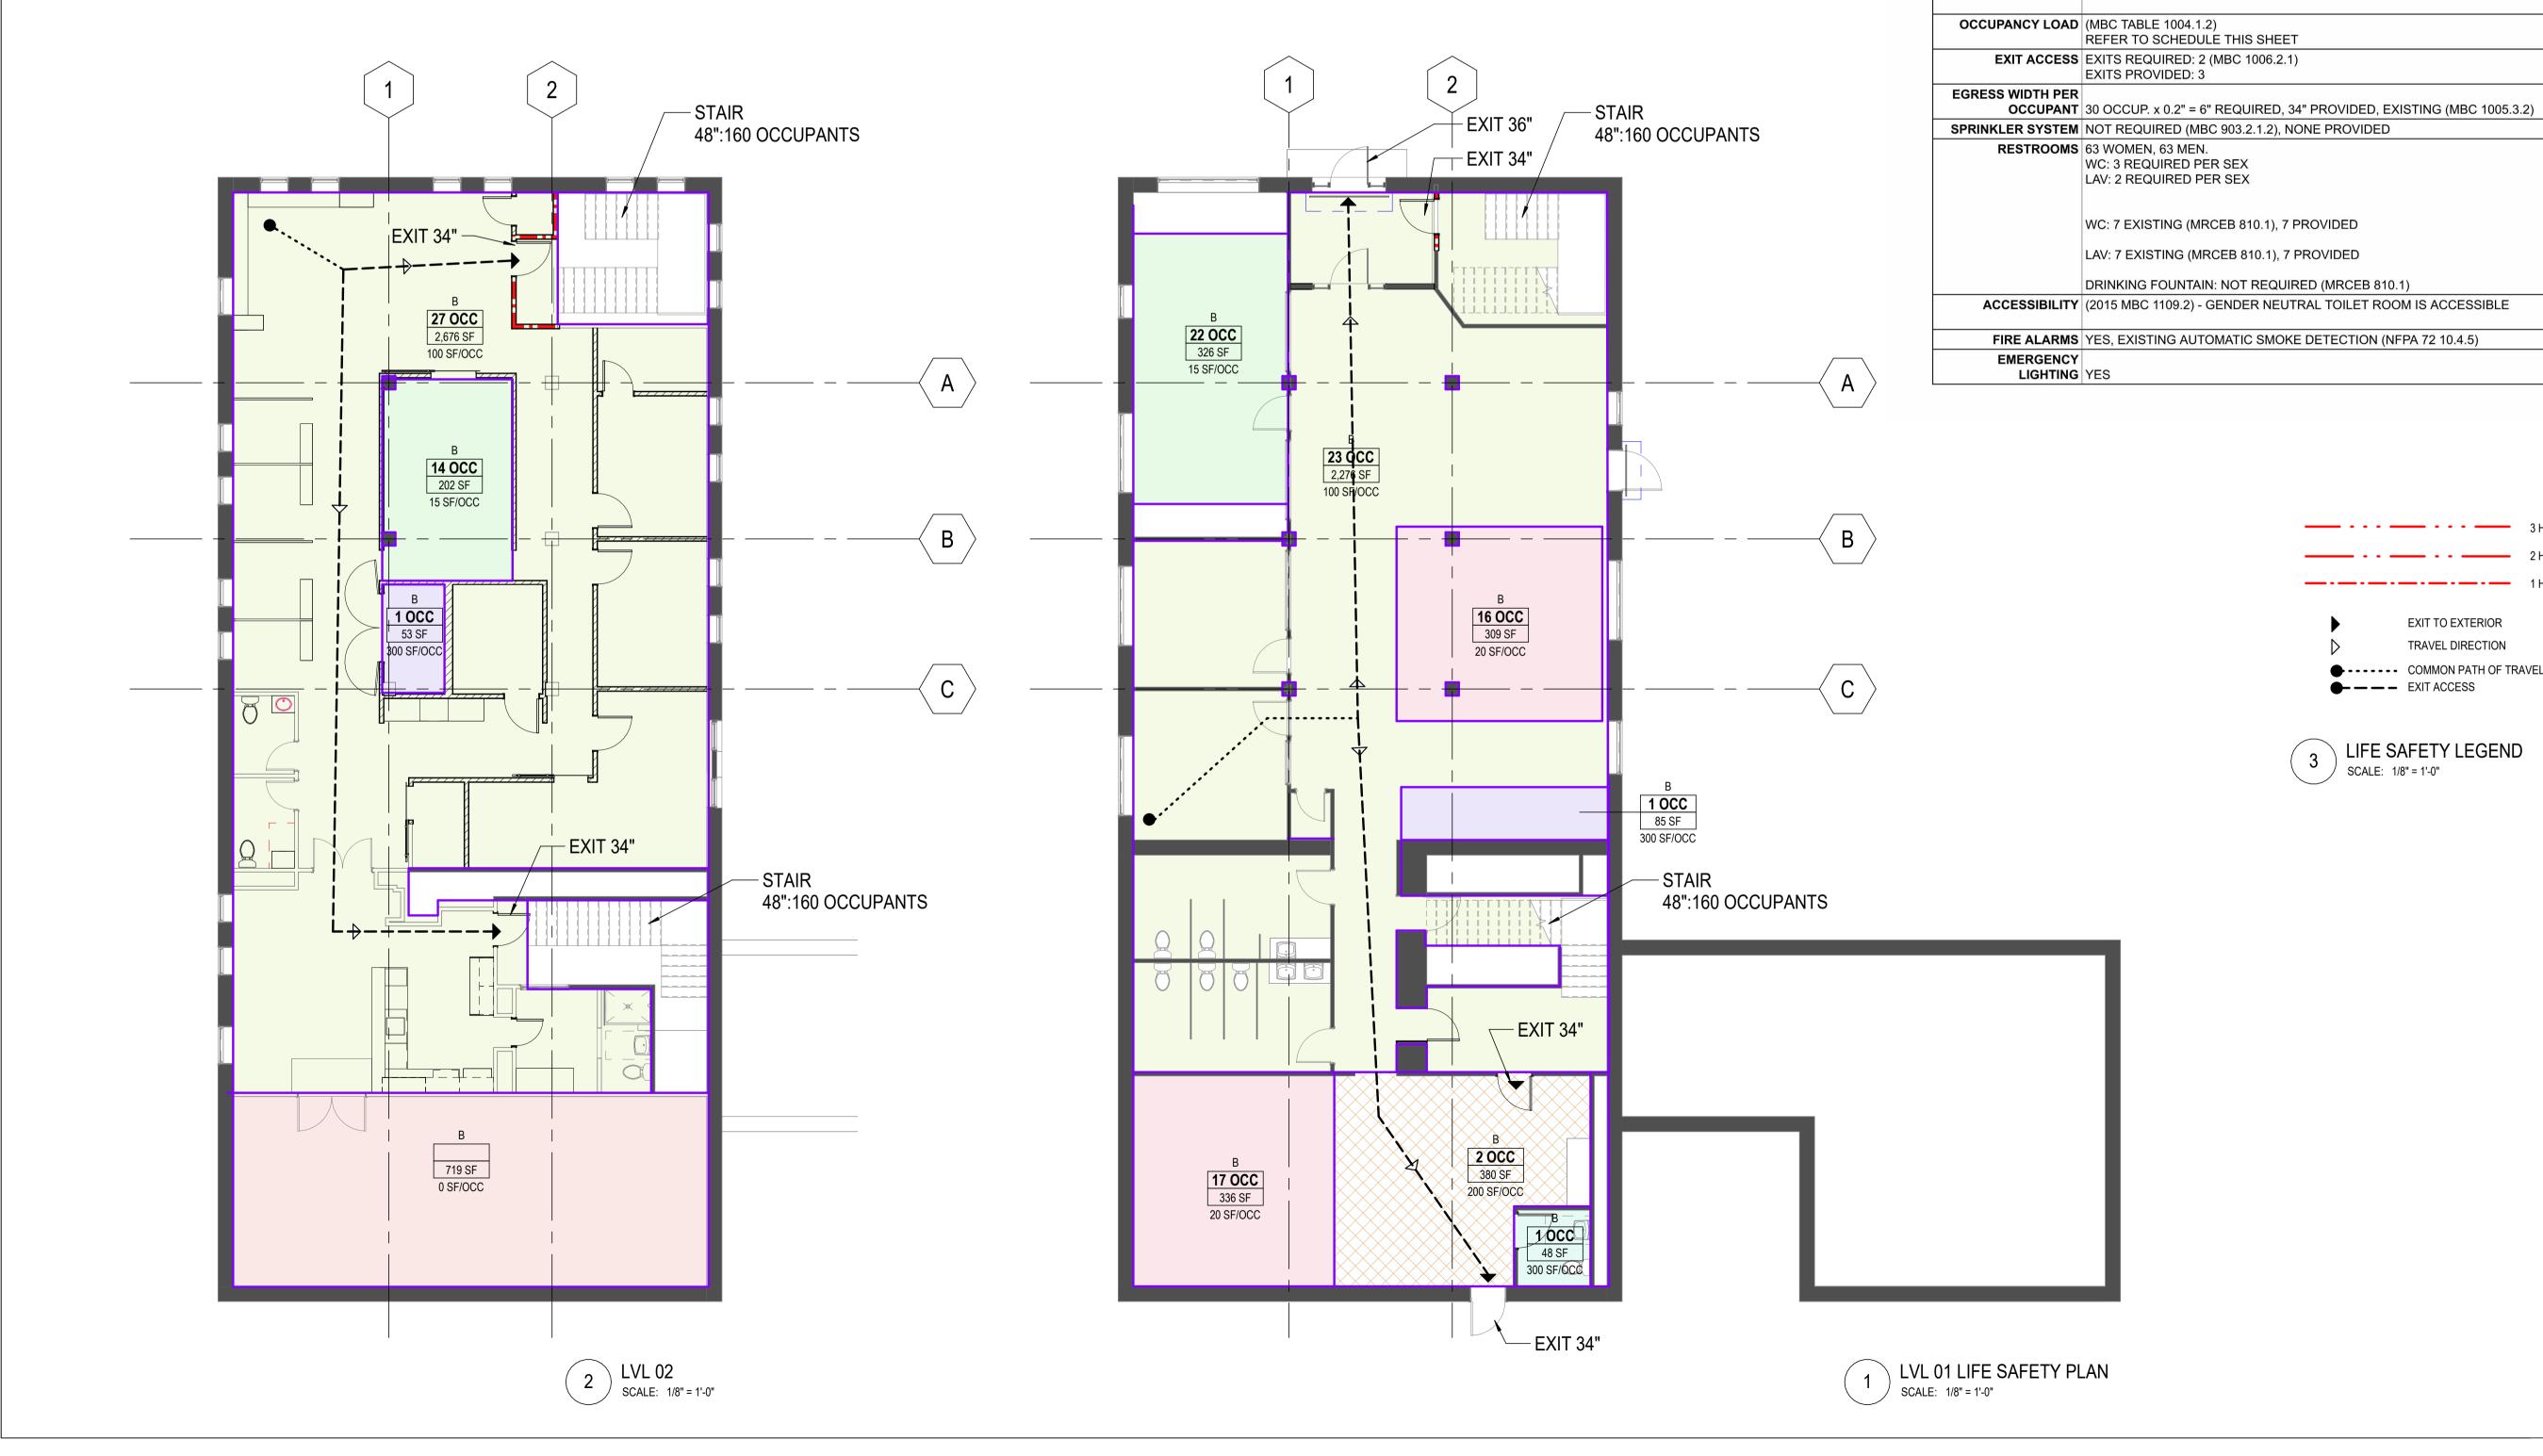

SECTION DESCRIPTION

MICHIGAN REHABILITATION

> REVIEW PREVIOUS OCCUPANCY

CHANGE OF

MRCEB Ch. 7 & 8

CLASSIFICATION AND

TOTAL FLOORS IN

REVIEW CODE | 2015 MICHIGAN REHABILITATION CODE FOR EXISTING BUILDINGS

2015 MICHIGAN EXISTING STRUCTURES CODE

2021 MICHIGAN MECHANICAL CODE 2021 MICHIGAN PLUMBING CODE

ICC/ANCI A117.1-2009

BLDG. 2 STORIES, 4,366 SF / FLOOR

CONSTRUCTION 3 STORIES, 19,000 SF ALLOWED. UNSPRINKLERED

BEARING WALLS - EXTERIOR: 2

NONBEARING WALLS AND PARTITIONS 0

FIRE RESISTANCE RATINGS: STRUCTURAL FRAME: 0

FLOOR CONSTRUCTION: 0 ROOF CONSTRUCTION: 0

USE GROUP B, BUSINESS (MBC 2015 309) TYPE OF TYPE III-B (MBC TABLE 601)

2015 MICHIGAN BUILDING CODE (AS REFERENCED BY MRCEB)

2023 Michigan Electrical Code. Adopts with Amendments NFPA 70, 2023

COMPLIANCE WORK AREA COMPLIANCE METHOD. ALTERATION - LEVEL 2 (CHAPTER 8) - NEW METHOD PARTITIONS, HVAC EQUIPMENT, ELECTRICAL OUTLIGHTS AND FIXTURES.

OCCUPANCY THE OCCUPANCY REMAINS BUSINESS. THE PROPOSED USE IS OFFICE SPACE

EXIT TO EXTERIOR TRAVEL DIRECTION

● - - - COMMON PATH OF TRAVEL

——— EXIT ACCESS

3 LIFE SAFETY LEGEND

) SCALE: 1/8" = 1'-0"

2017 Michigan Electrical Code based on 2014 N.E.C. with Part 8 State Amendments

2015 MICHIGAN ENERGY CODE ANSI/ASHRAE/IESNA Standard 90.1-2013

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CONSTRUCTION DOCUMENTS	1	06NO

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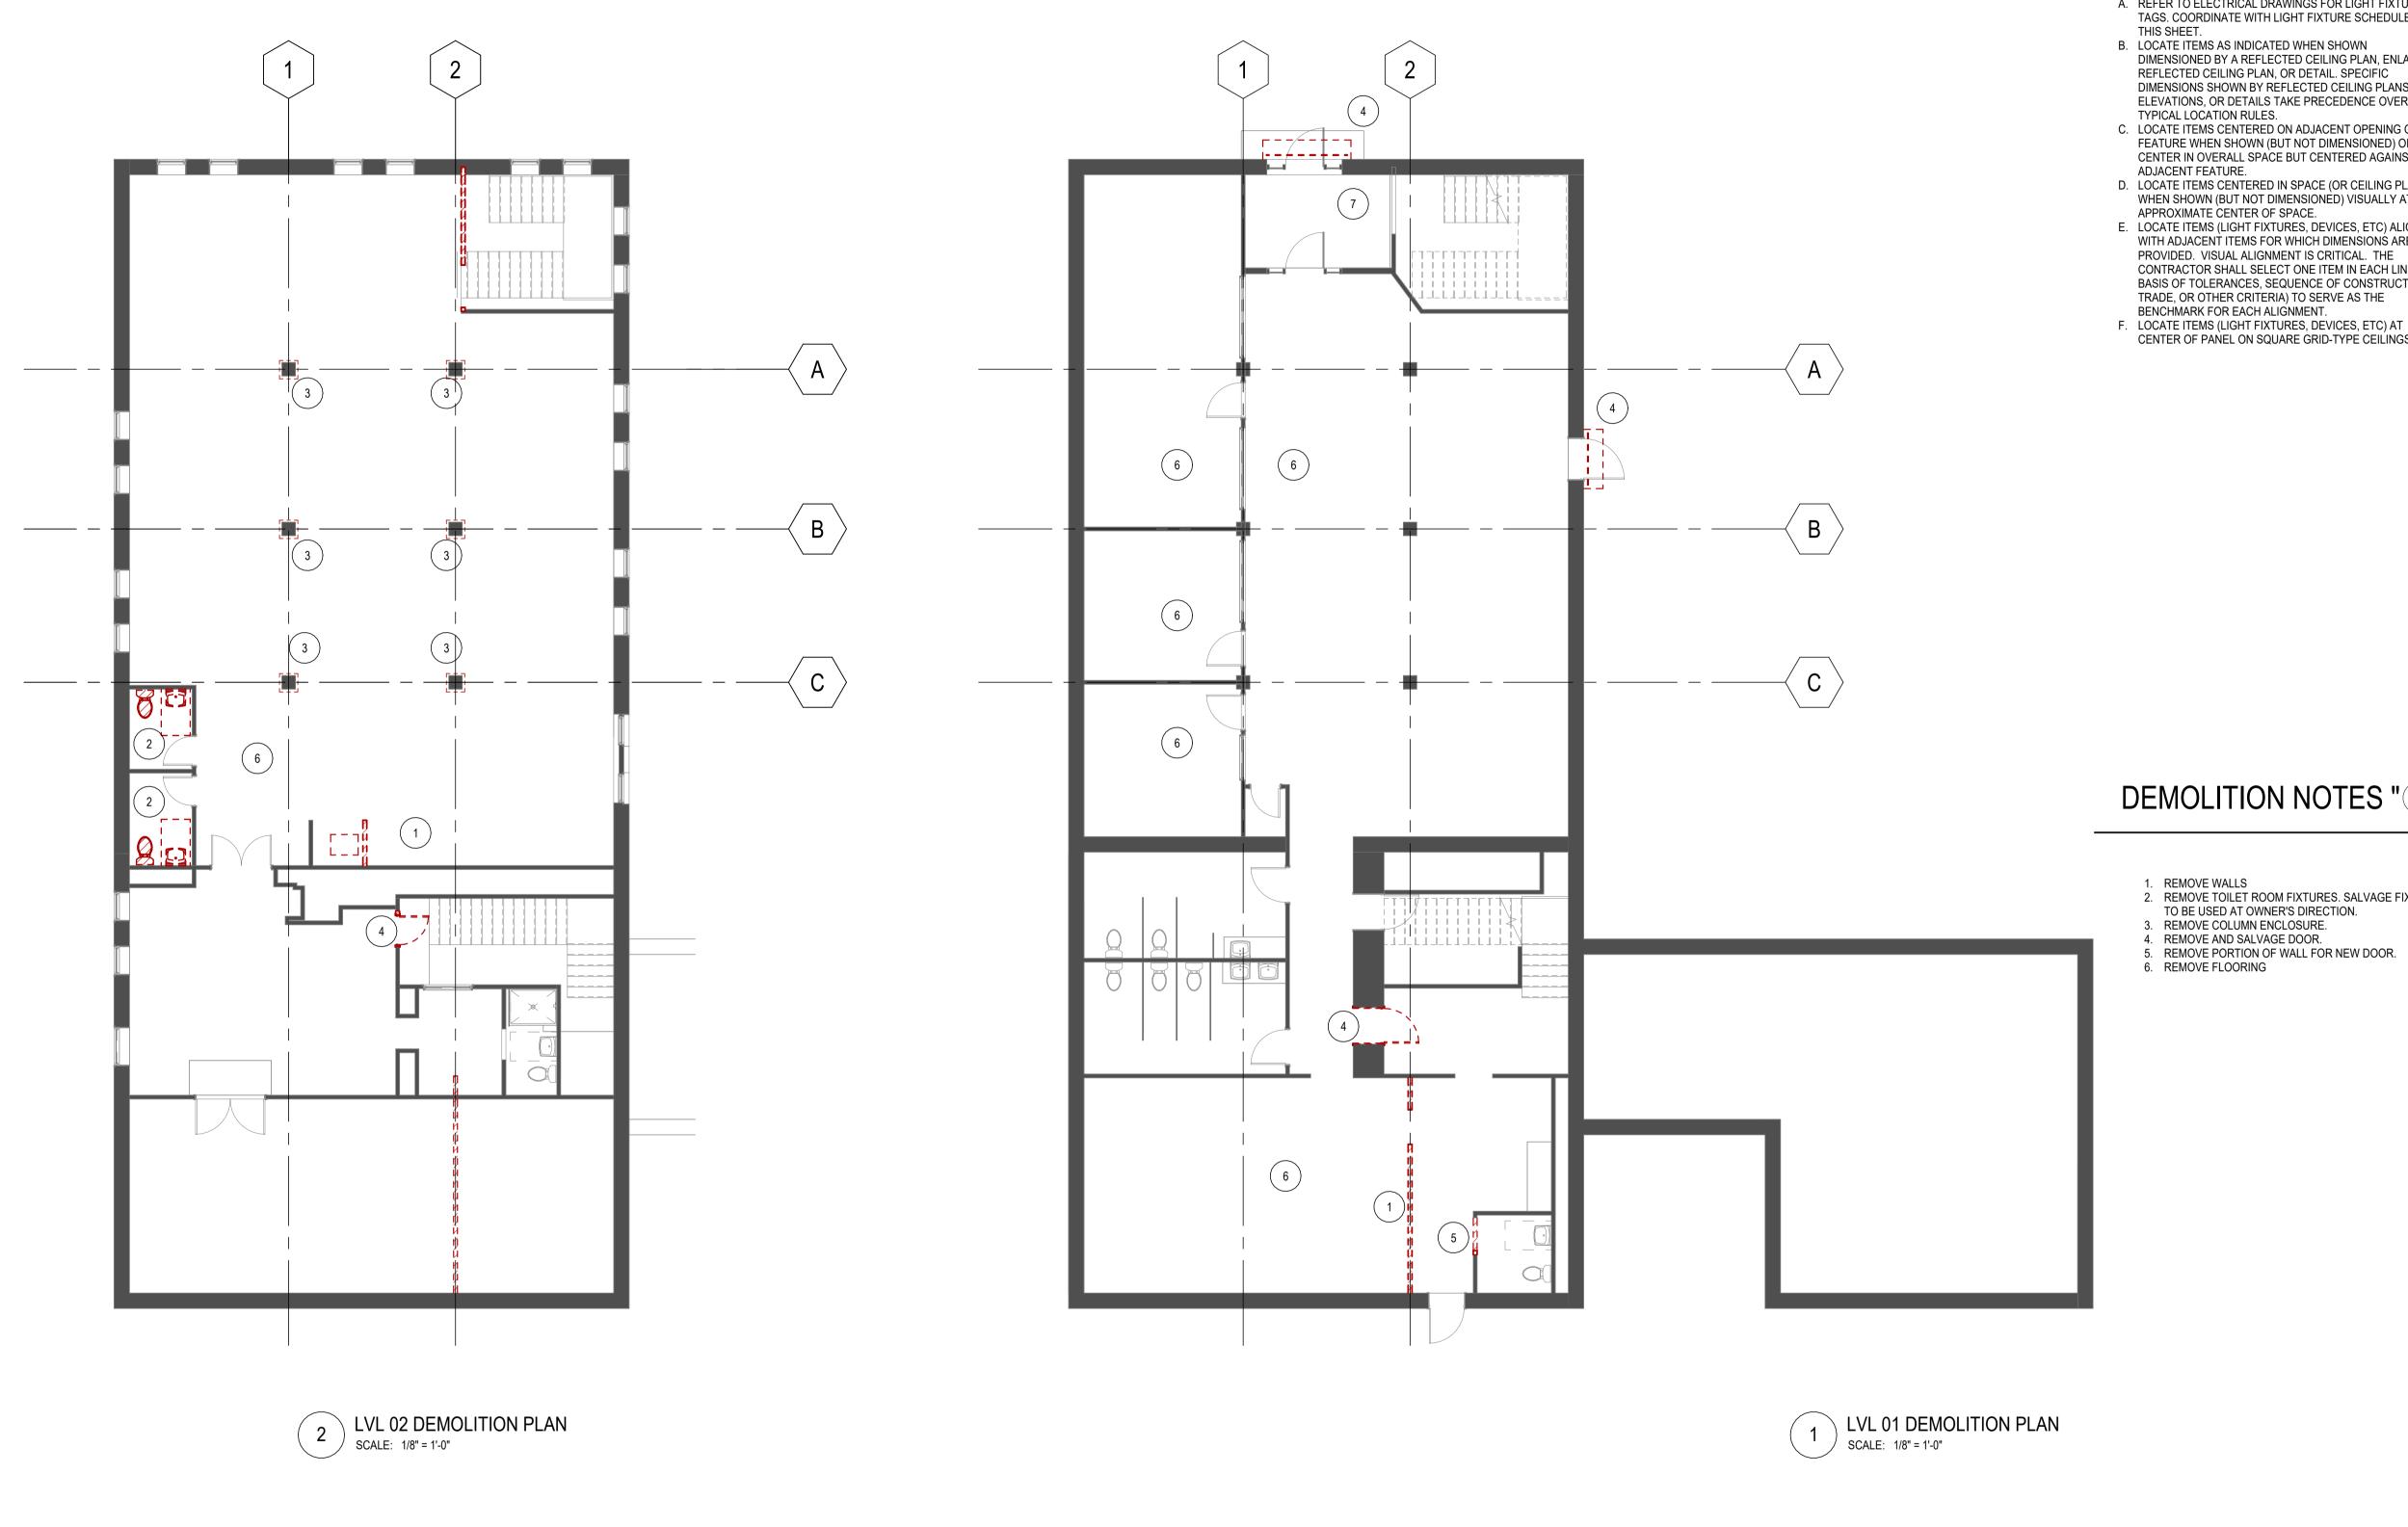
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LIFE SAFETY PLAN & CODE ANALYSIS

PROJECT NORTH





GENERAL SHEET NOTES

- A. REFER TO ELECTRICAL DRAWINGS FOR LIGHT FIXTURE TAGS. COORDINATE WITH LIGHT FIXTURE SCHEDULE ON
- B. LOCATE ITEMS AS INDICATED WHEN SHOWN DIMENSIONED BY A REFLECTED CEILING PLAN, ENLARGED REFLECTED CEILING PLAN, OR DETAIL. SPECIFIC DIMENSIONS SHOWN BY REFLECTED CEILING PLANS, ELEVATIONS, OR DETAILS TAKE PRECEDENCE OVER
- C. LOCATE ITEMS CENTERED ON ADJACENT OPENING OR FEATURE WHEN SHOWN (BUT NOT DIMENSIONED) OFF-CENTER IN OVERALL SPACE BUT CENTERED AGAINST
- D. LOCATE ITEMS CENTERED IN SPACE (OR CEILING PLANE) WHEN SHOWN (BUT NOT DIMENSIONED) VISUALLY AT
- E. LOCATE ITEMS (LIGHT FIXTURES, DEVICES, ETC) ALIGNED WITH ADJACENT ITEMS FOR WHICH DIMENSIONS ARE PROVIDED. VISUAL ALIGNMENT IS CRITICAL. THE CONTRACTOR SHALL SELECT ONE ITEM IN EACH LINE (ON BASIS OF TOLERANCES, SEQUENCE OF CONSTRUCTION, TRADE, OR OTHER CRITERIA) TO SERVE AS THE
- F. LOCATE ITEMS (LIGHT FIXTURES, DEVICES, ETC) AT CENTER OF PANEL ON SQUARE GRID-TYPE CEILINGS.

DEMOLITION NOTES " "

- REMOVE WALLS
 REMOVE TOILET ROOM FIXTURES. SALVAGE FIXTURES

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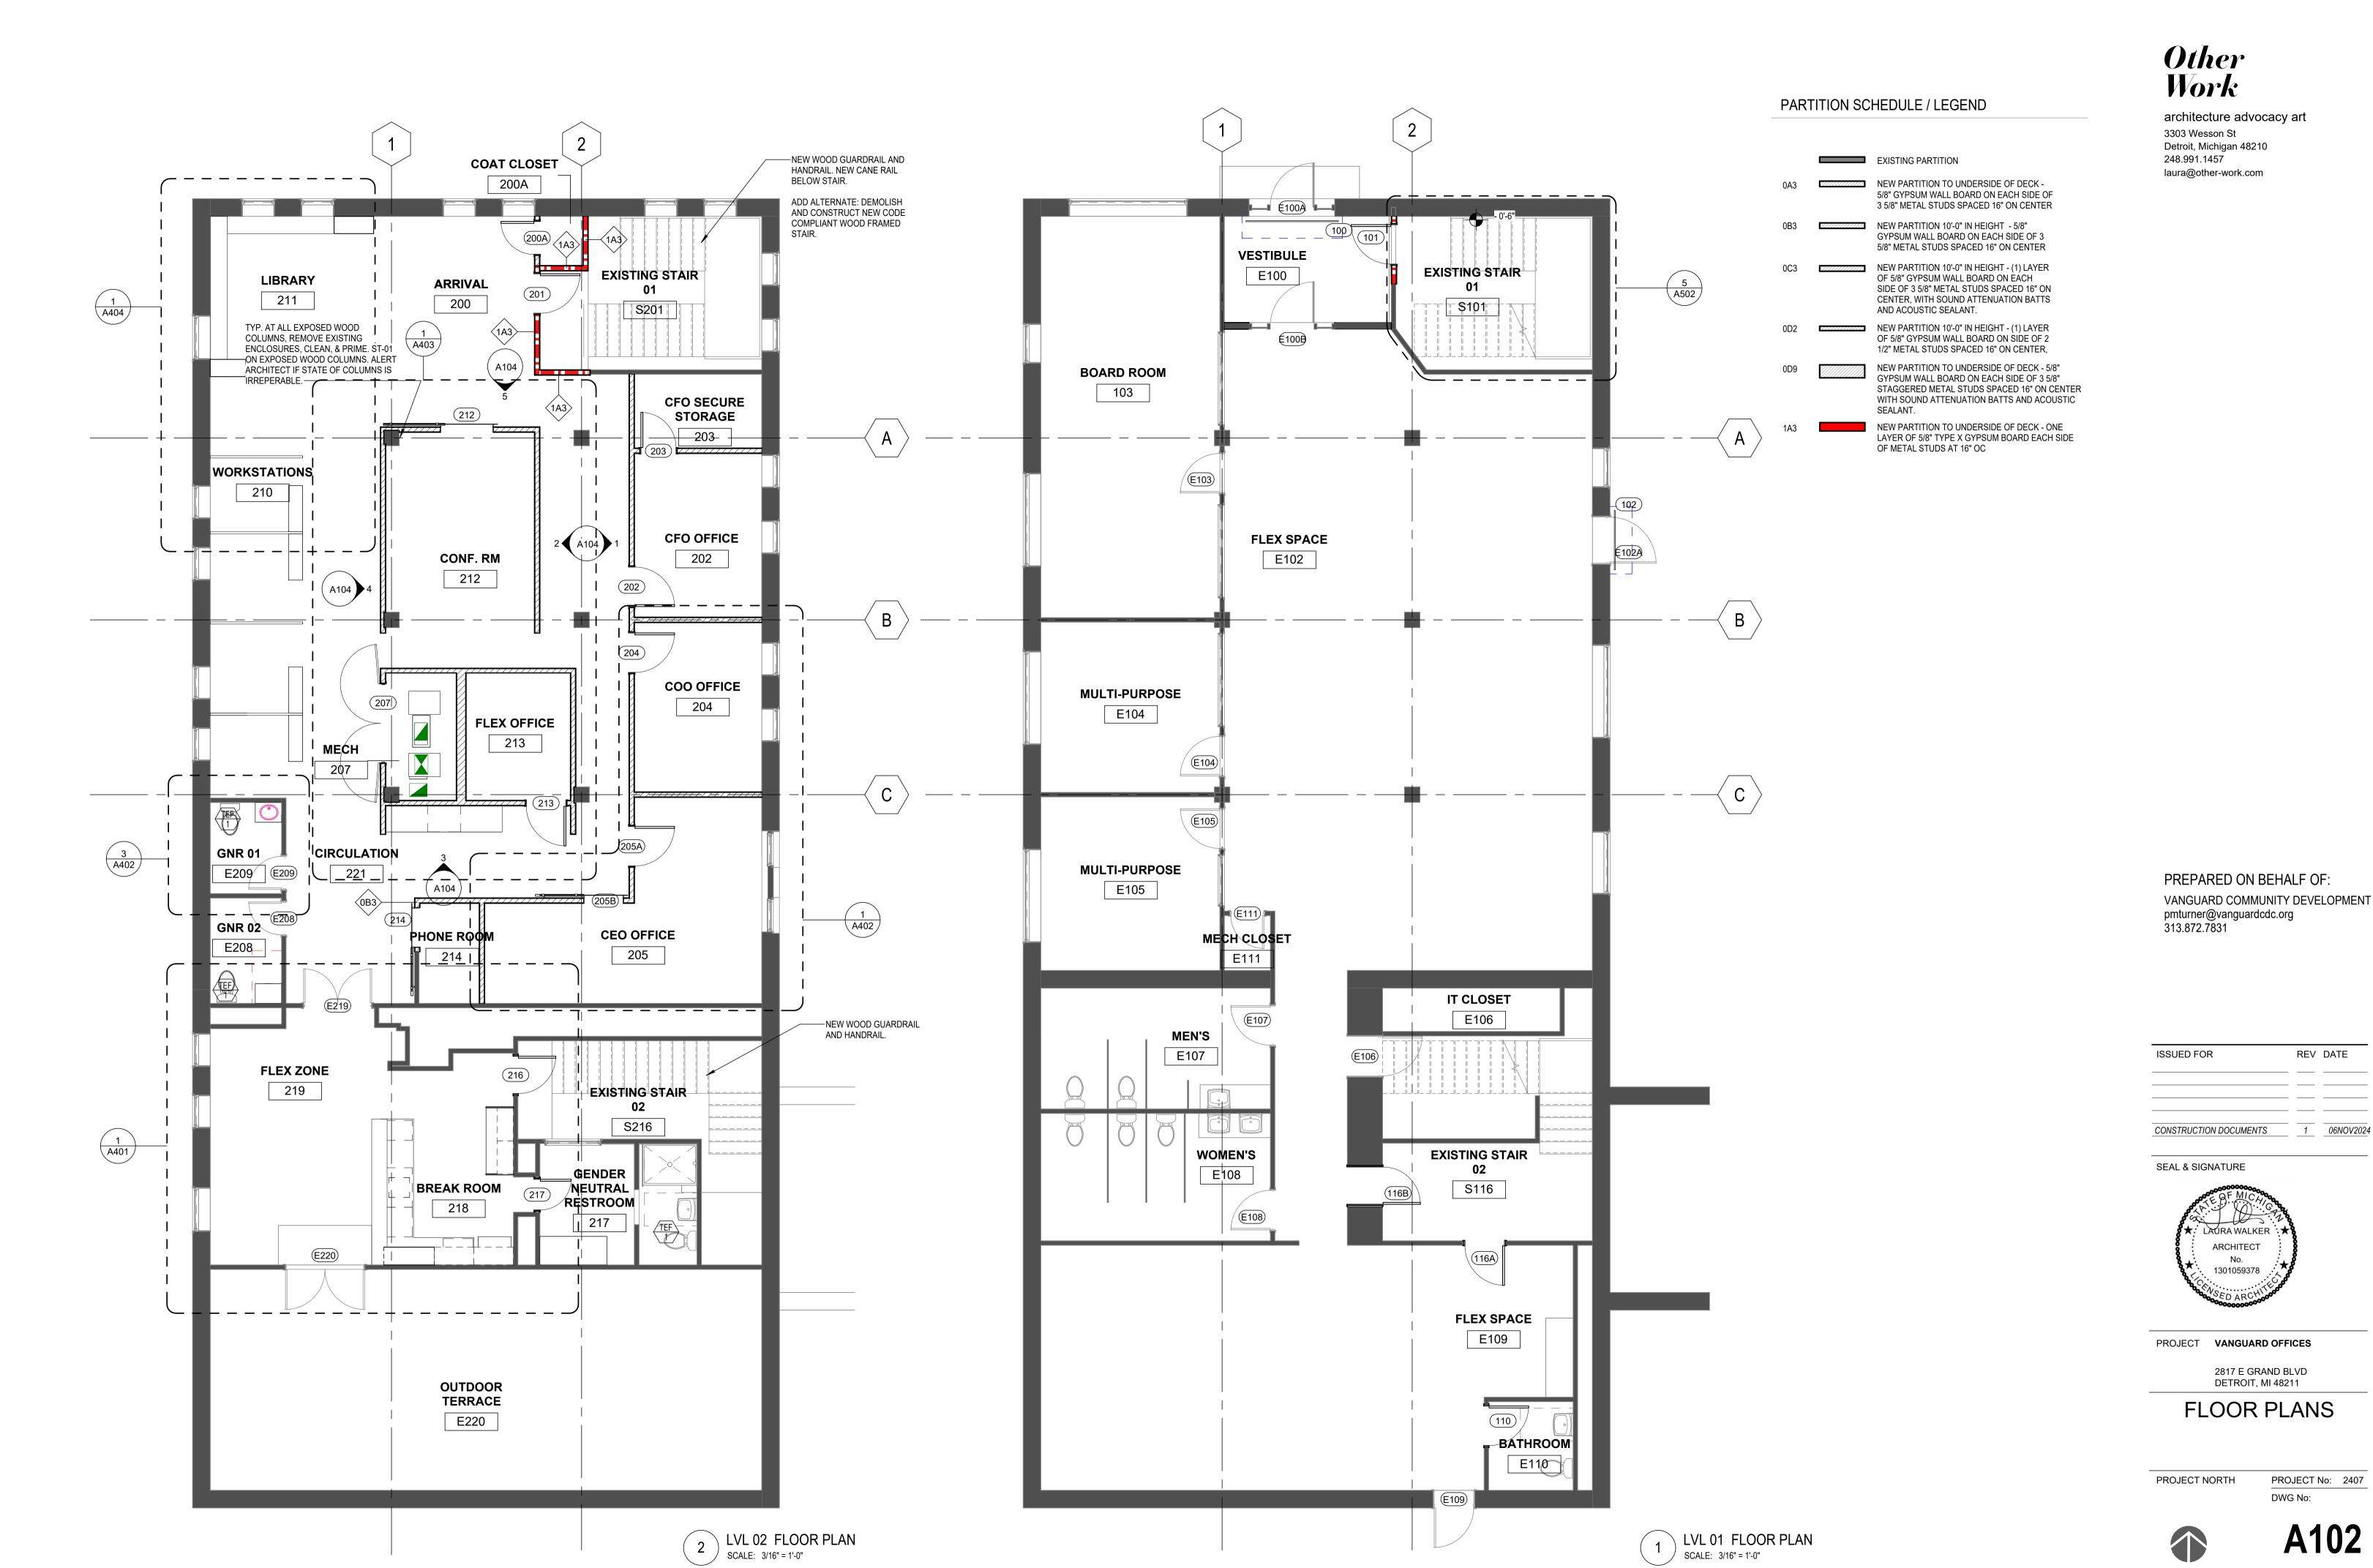
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DEMOLITION PLANS

PROJECT NORTH








VANGUARD COMMUNITY DEVELOPMENT

ISSUED FOR	REV	DATE
CONSTRUCTION DOCUMENTS		06NOV202

		1						
TAG	DESCRIPTION	MANUFACTURER	MODEL #	LAMP	WATTS	FINISH	INSTALLATION	NOTES
L1	SUSPENDED LED CAN; CORD MOUNT W/OVERSIZED CANOPY;	GOTHAM	EVO6 CC	120V; 0-10V 10% DIMMING; 1500L; 3500K; 80+CRI	14			MOUNT 9' AFF
EM-L1	SAME AS L1, EXCEPT WITH EMERGENCY POWER.							
L2	4' RECESSED LINEAR LED LIGHT	MARK ARCHITECTURAL LIGHTING	Slot 4 RECESSED	120V; 0-10V 1% DIMMING; 800 L/FT; 3500K; 80+CRI	8	WHITE	CONTRACTOR PROVIDED AND INSTALLED	RECESSED IN T GRID
L3	4' LONG WALL MOUNT LED DIRECT/ INDIRECT, TUNABLE WHITE SCONCE. SILVER	MARK ARCHITECTURAL LIGHTING	SLOT 4 LED WALL	120V; 0-10V 1% DIMMING; 800 L/FT; 3500K; 80+CRI	8	SILVER	CONTRACTOR PROVIDED AND INSTALLED	
L4	DECORATIVE PENDANT	TBD	TBD	120V; 0-10V, 1000L; 3500K; 80+CRI	TBD	TBD		DECORATIVE PENDANT IN BREAK ROOM
L5	4' SUSPENDED LINEAR LED LIGHT, BLACK CORD MOUNT	MARK ARCHITECTURAL LIGHTING	SLOT 4 PENDANT DIRECT	120V; 0-10V 1% DIMMING; 800 L/FT; 3500K; 80+CRI	6.33/FT	BLACK		REGRESSED LOUVE MOUNT 9' AFF.

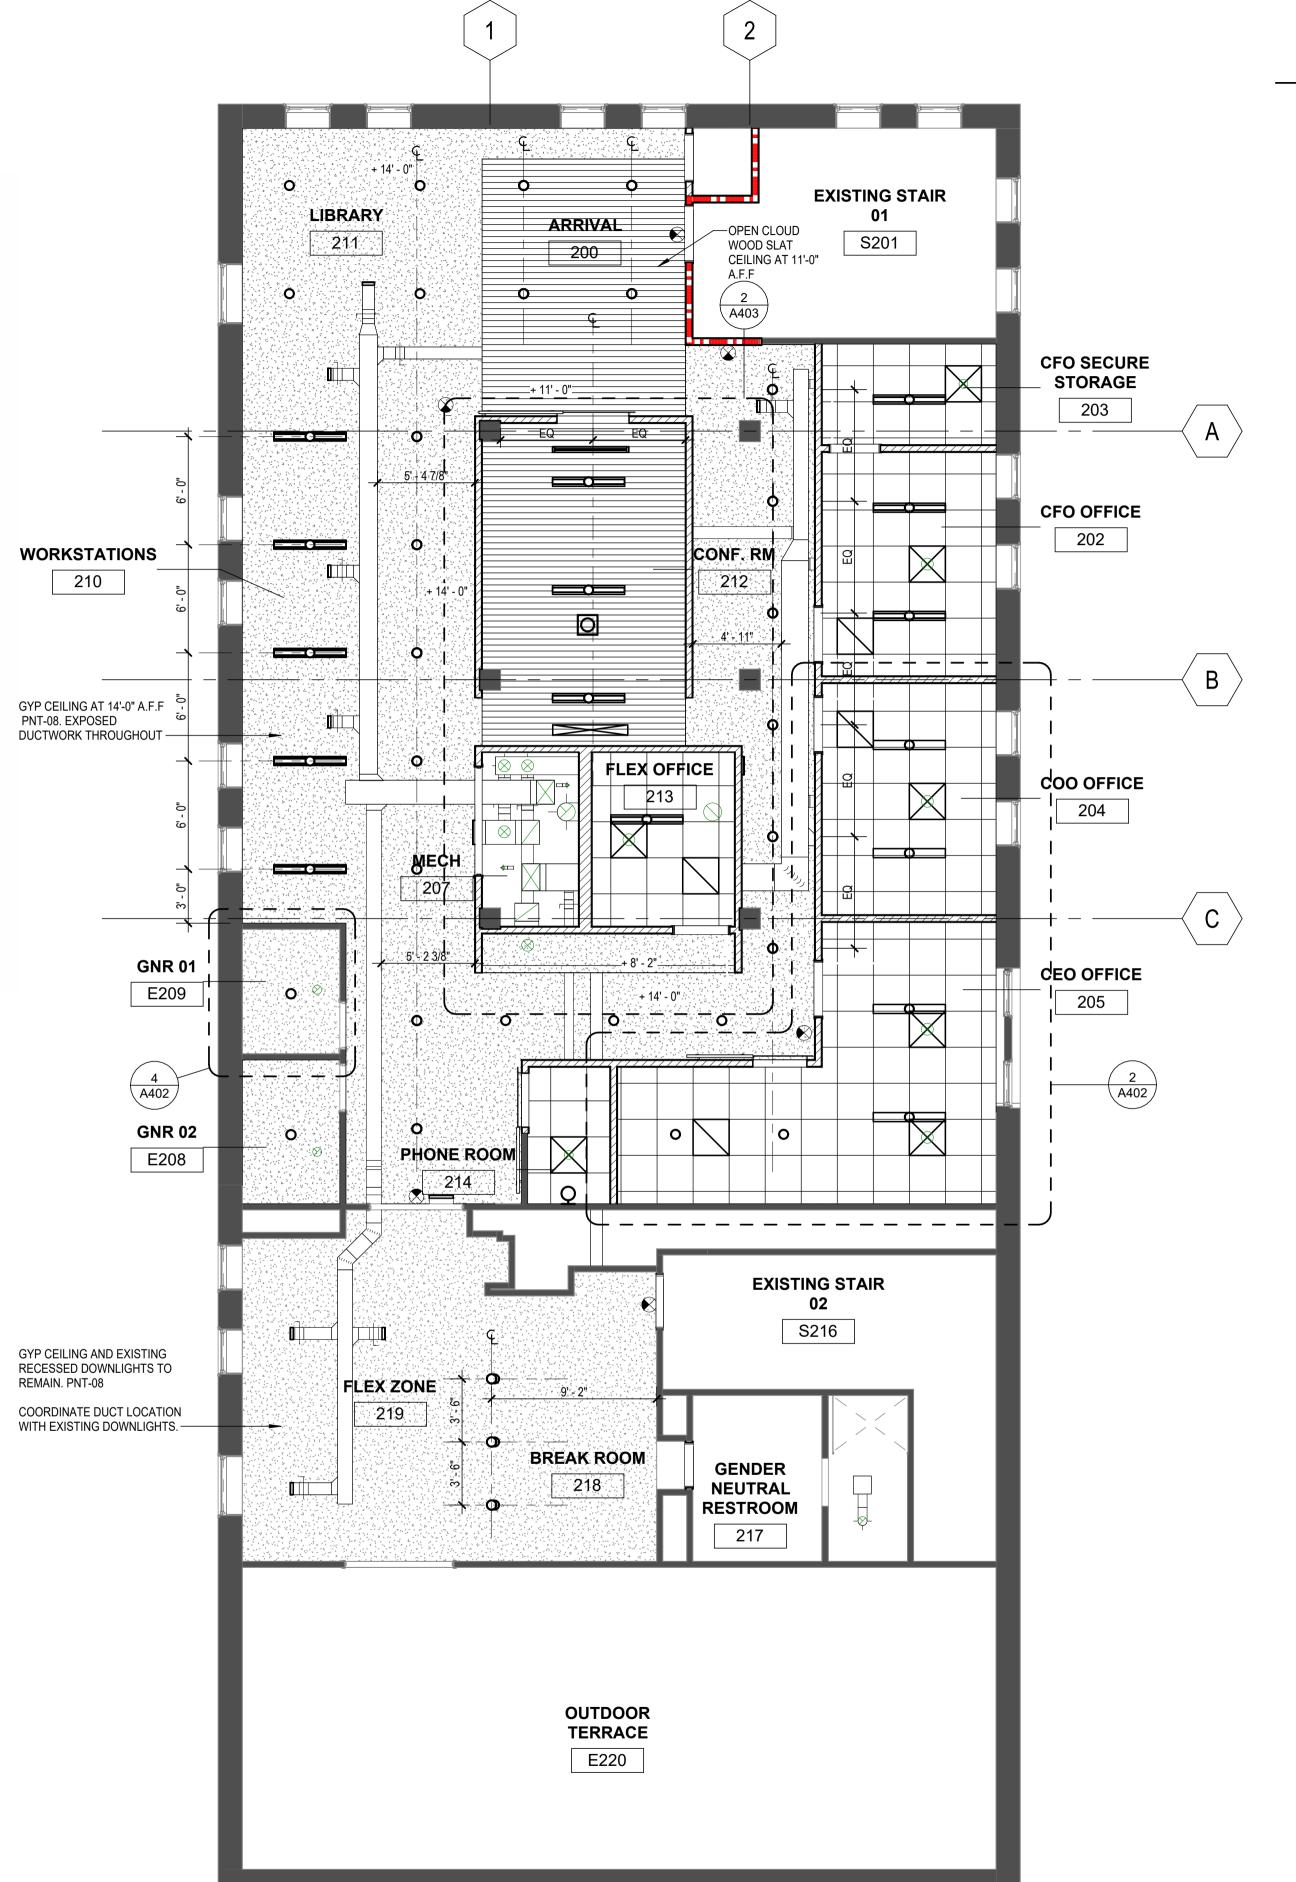

GENERAL SHEET NOTES

- A. REFER TO ELECTRICAL DRAWINGS FOR LIGHT FIXTURE TAGS. COORDINATE WITH LIGHT FIXTURE SCHEDULE ON THIS SHEET.
- B. LOCATE ITEMS AS INDICATED WHEN SHOWN
 DIMENSIONED BY A REFLECTED CEILING PLAN, ENLARGED
 REFLECTED CEILING PLAN, OR DETAIL. SPECIFIC
 DIMENSIONS SHOWN BY REFLECTED CEILING PLANS,
 ELEVATIONS, OR DETAILS TAKE PRECEDENCE OVER
 TYPICAL LOCATION RULES.
- C. LOCATE ITEMS CENTERED ON ADJACENT OPENING OR FEATURE WHEN SHOWN (BUT NOT DIMENSIONED) OFF-CENTER IN OVERALL SPACE BUT CENTERED AGAINST ADJACENT FEATURE.
- D. LOCATE ITEMS CENTERED IN SPACE (OR CEILING PLANE)
 WHEN SHOWN (BUT NOT DIMENSIONED) VISUALLY AT
 APPROXIMATE CENTER OF SPACE.
- E. LOCATE ITEMS (LIGHT FIXTURES, DEVICES, ETC) ALIGNED WITH ADJACENT ITEMS FOR WHICH DIMENSIONS ARE PROVIDED. VISUAL ALIGNMENT IS CRITICAL. THE CONTRACTOR SHALL SELECT ONE ITEM IN EACH LINE (ON BASIS OF TOLERANCES, SEQUENCE OF CONSTRUCTION, TRADE, OR OTHER CRITERIA) TO SERVE AS THE BENCHMARK FOR EACH ALIGNMENT.
- F. LOCATE ITEMS (LIGHT FIXTURES, DEVICES, ETC) AT CENTER OF PANEL ON SQUARE GRID-TYPE CEILINGS.

Other Work

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REFLECTED CEILING PLANS


PROJECT NORTH

DWG No:

PROJECT No: 2407


A103



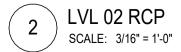




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INTERIOR ELEVATIONS

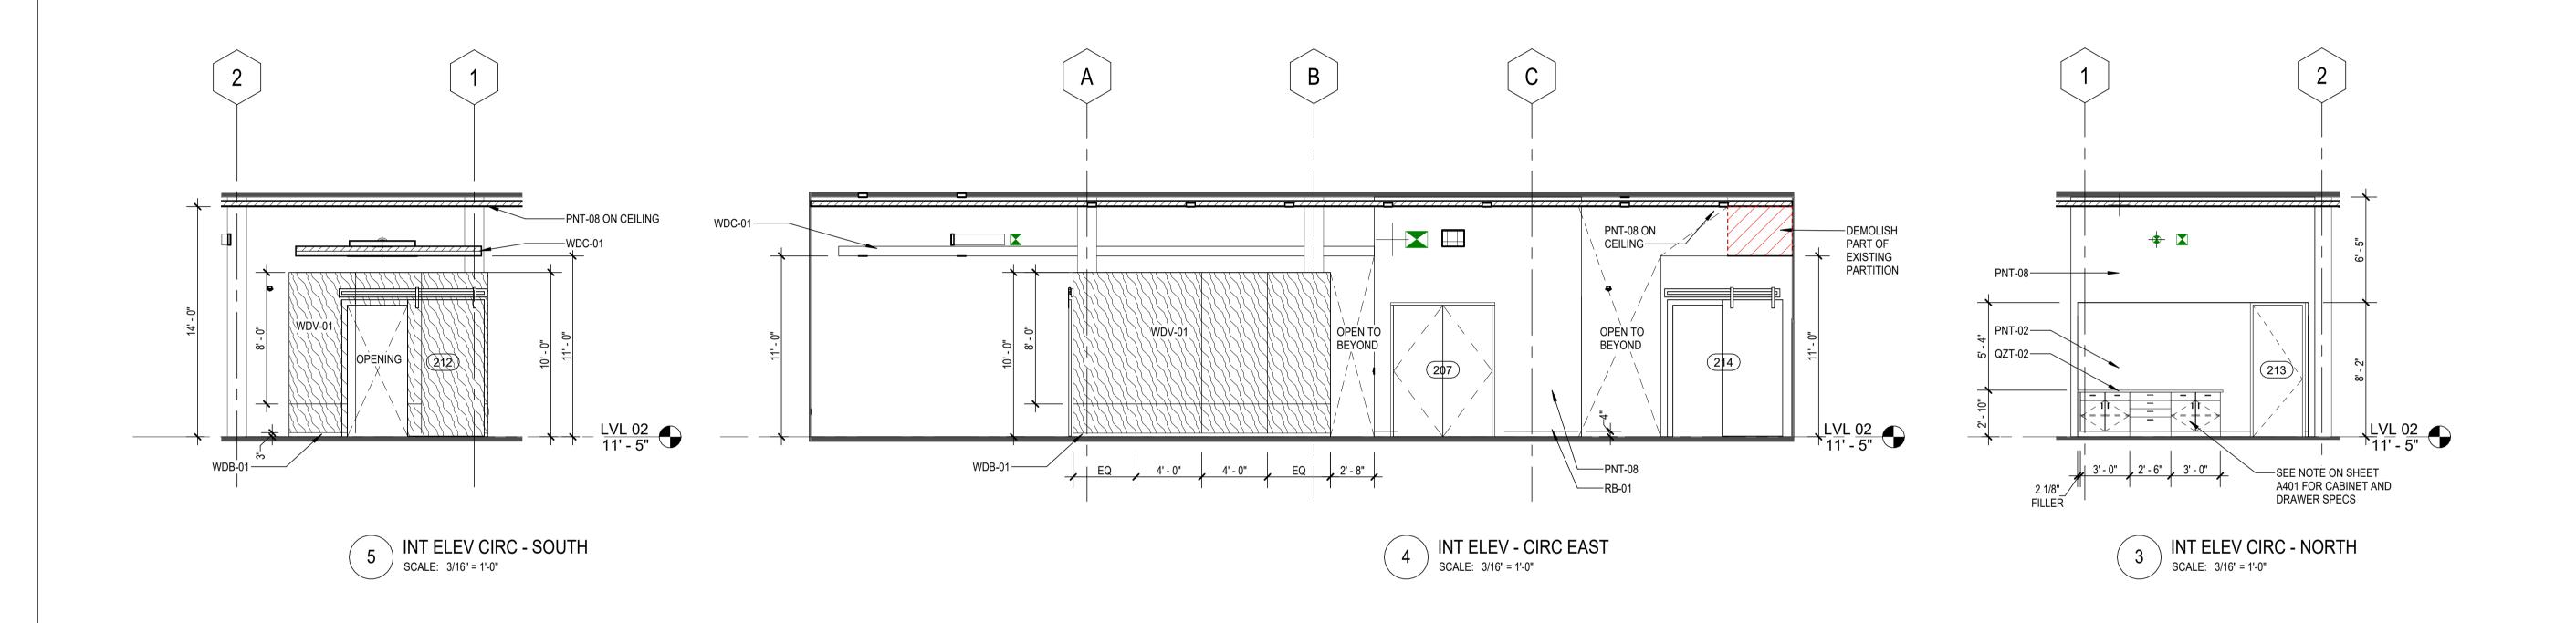
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DWG No:

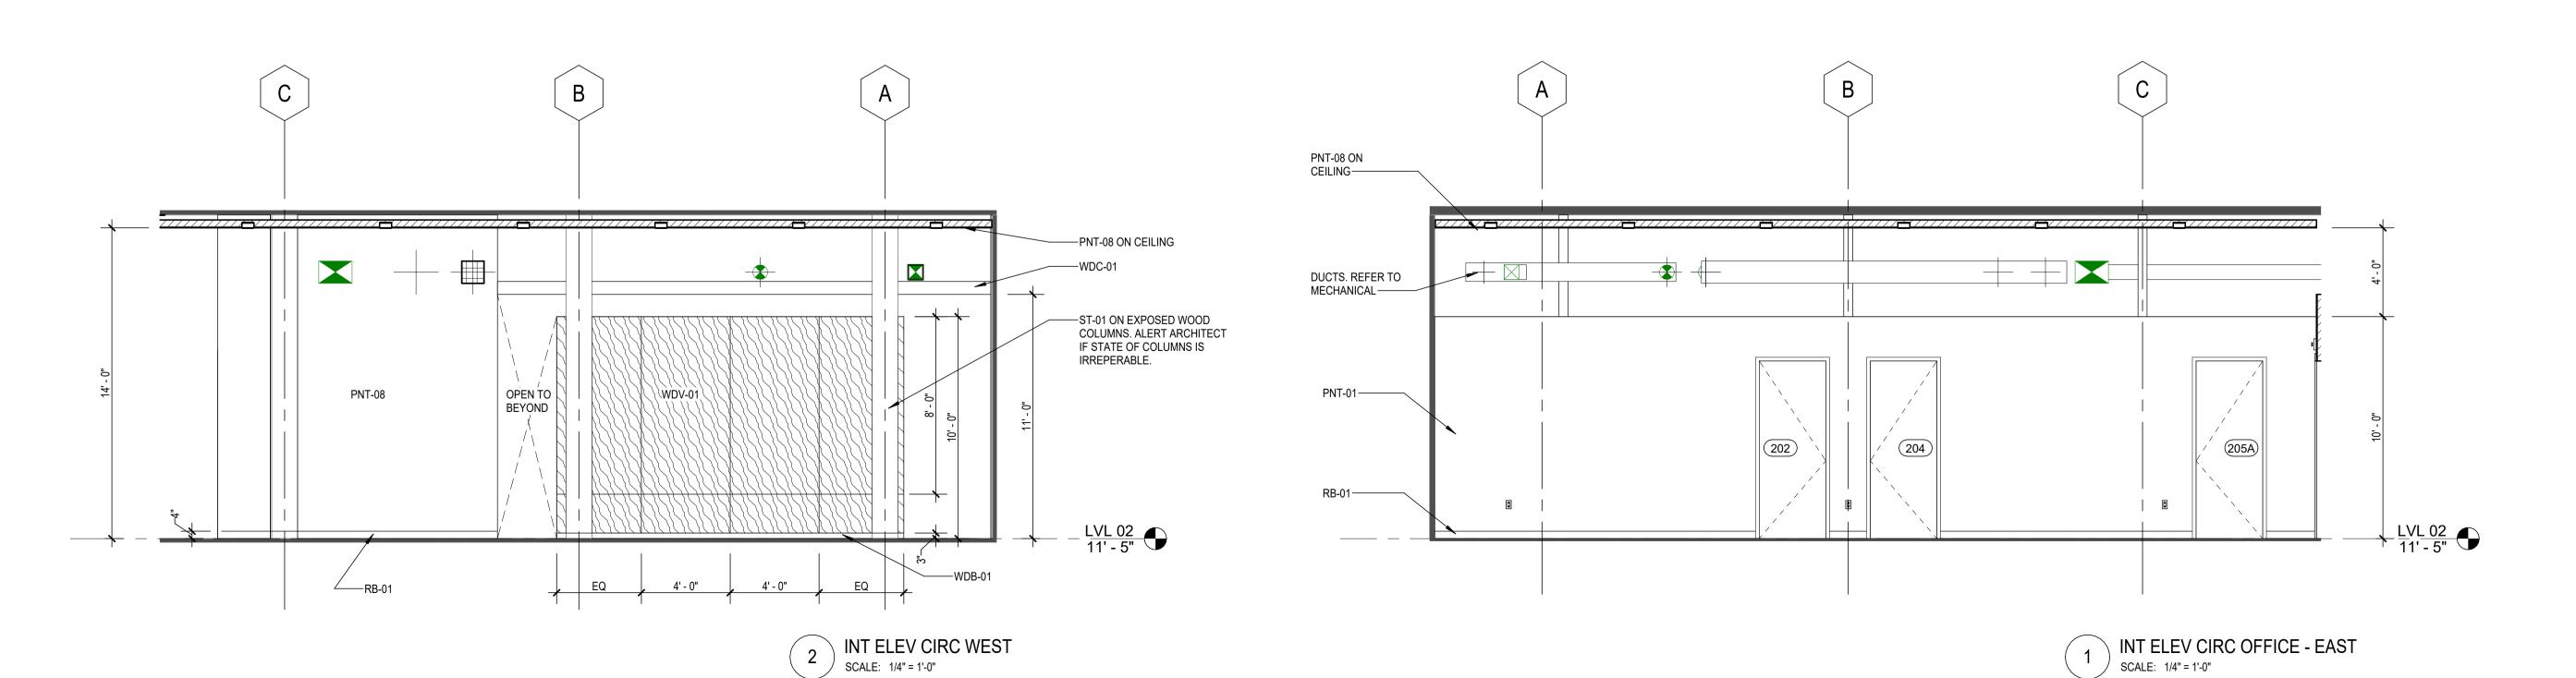

A104




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CABINETRY AND MILLWORK NOTES

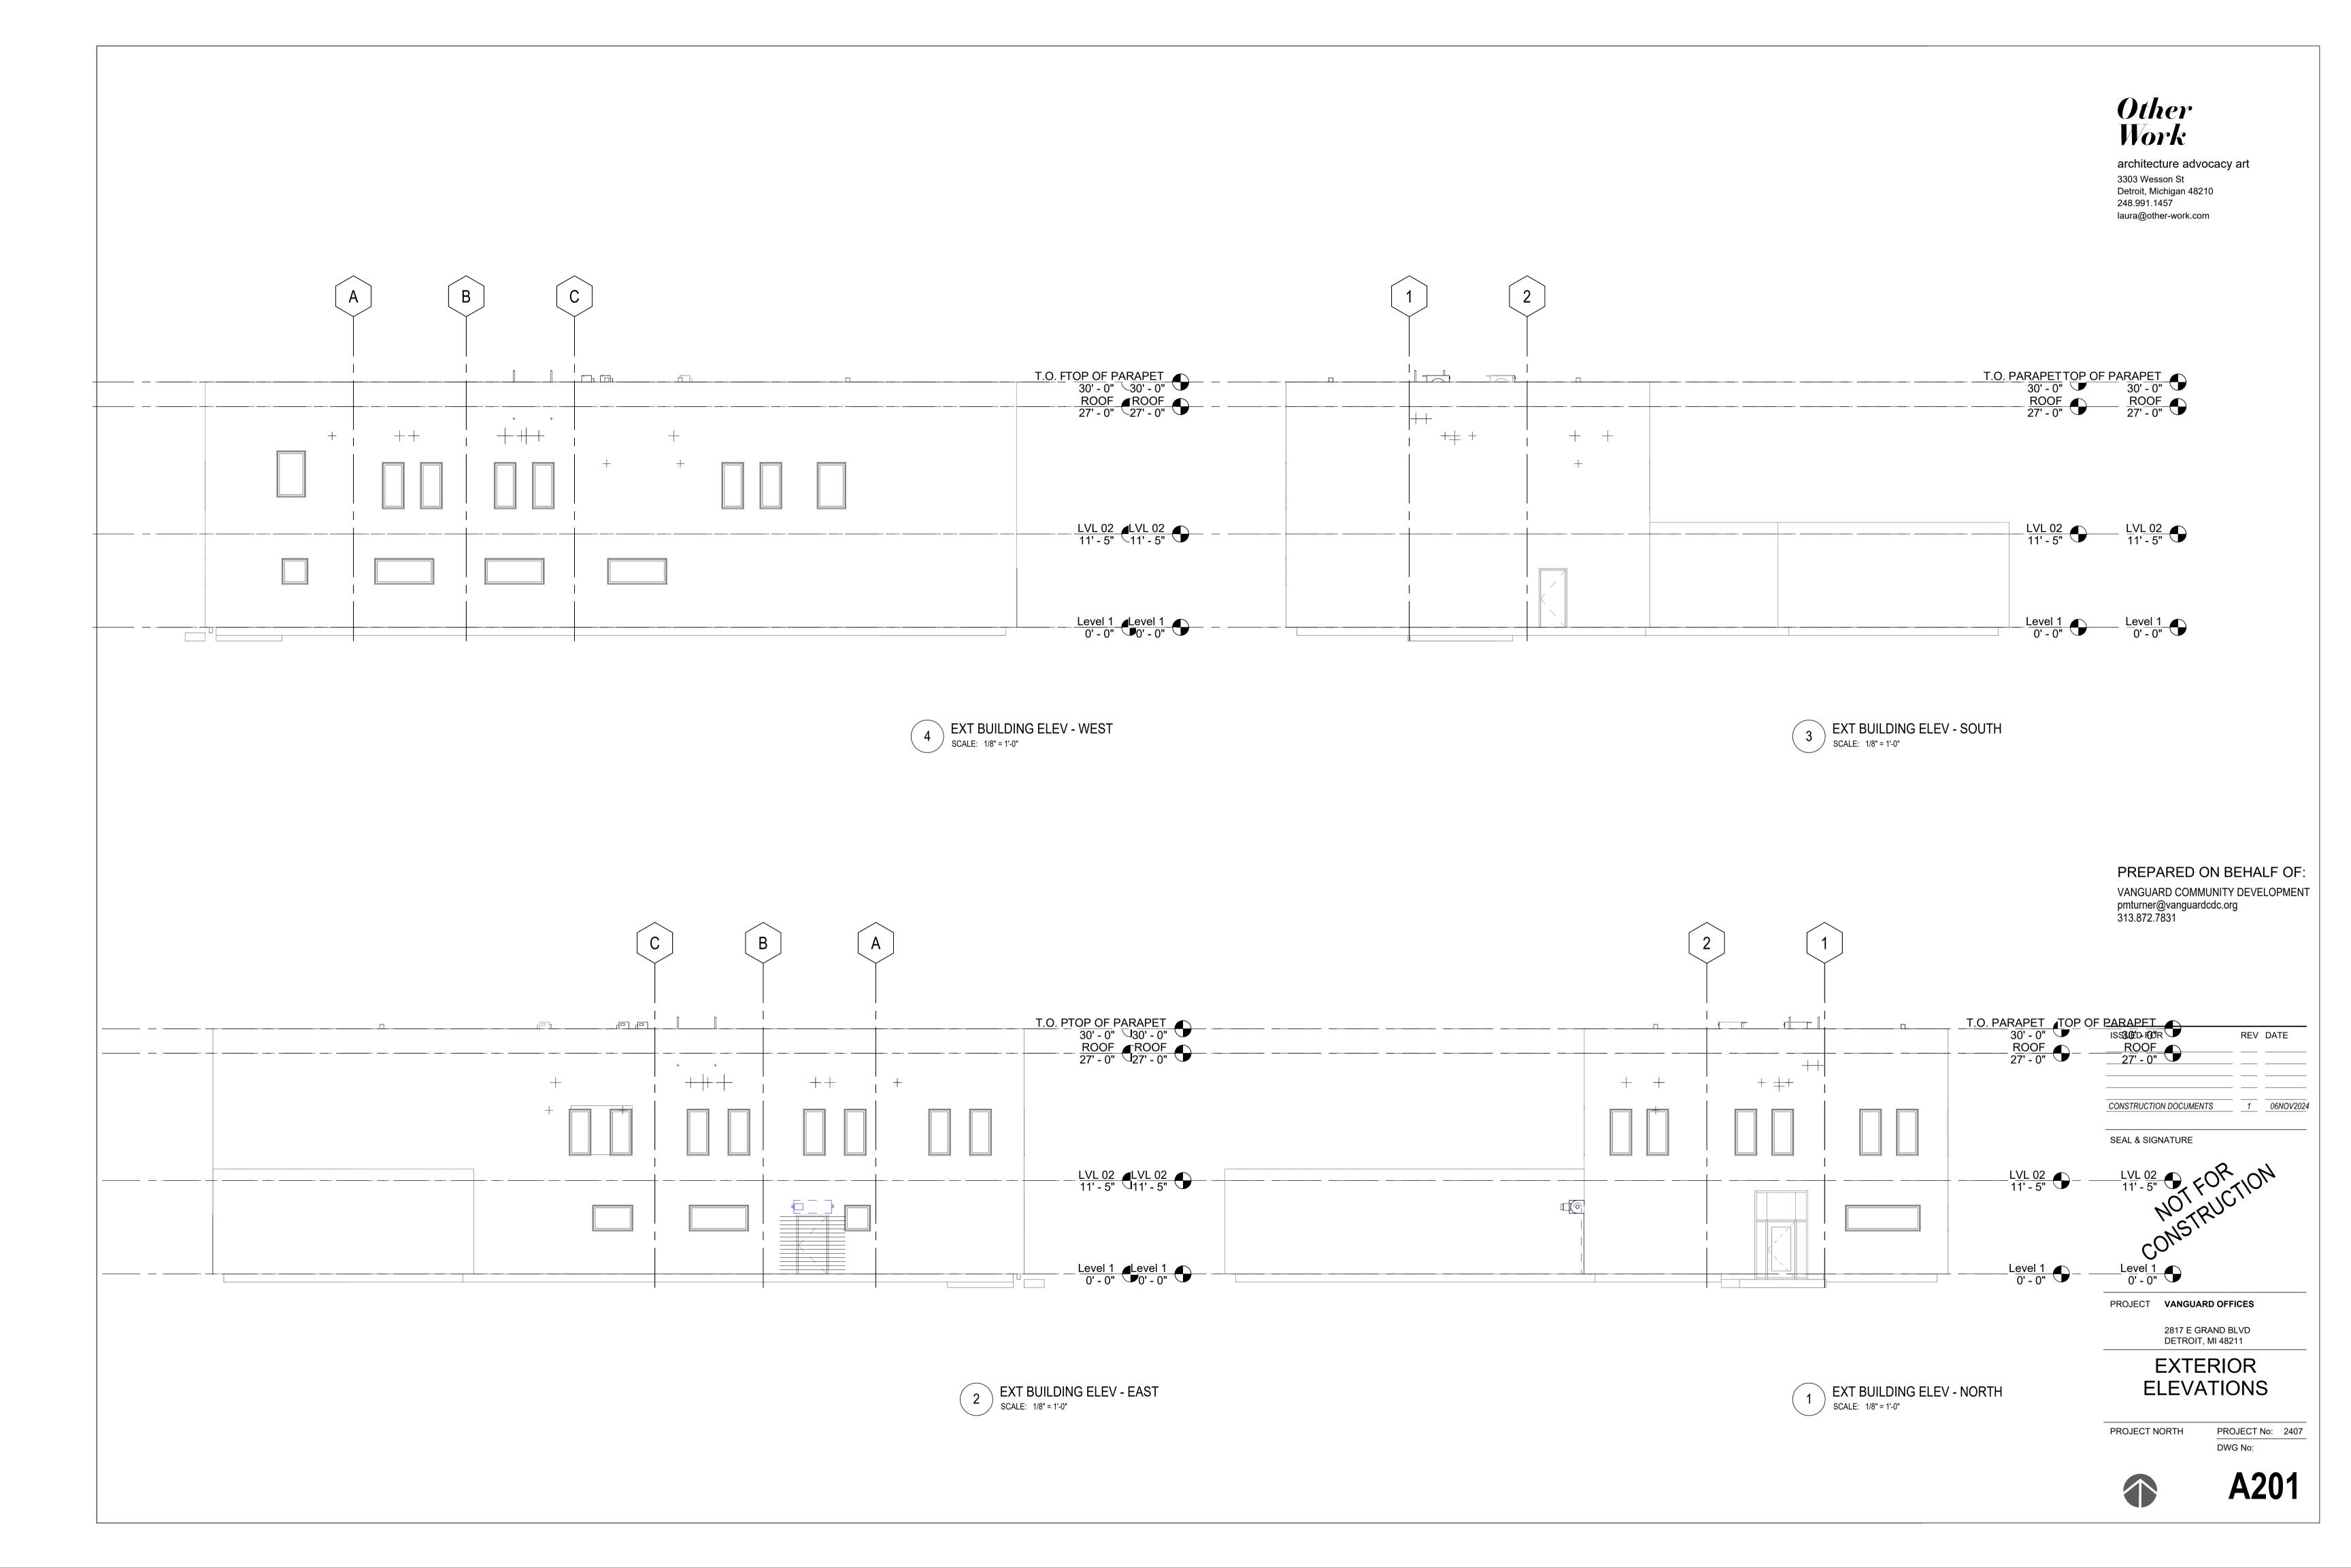CABINETS, DRAWERS, SHELVES, AND MILLWORK IN THE BREAKROOM, SUPPLIES AREA, GNR 01 AND GNR 02 SHALL BE THE FOLLOWING, UNLESS OTHERWISE NOTED:

CABINETRY MANUFACTURER: DCI CABINETS DIRECT: (248) 310-1926
DOOR STYLE: RUSHMORE ON HDF CORE
CONSTRUCTION: FULL PLYWOOD WITH SOLID FRAME AND DOOR FRAMES
DRAWERS: SOLID BIRCH, DOVETAILED WITH 3/8" PLYWOOD BOTTOMS
DRAWER TRACKS: SOFT CLOSING FULL EXTENSION UNDERMOUNT
HINGES: SOFT CLOSING 6-WAY ADJUSTABLE FACE FRAME, 110 OPENING
FINISH: CONVERSION VARNISH NON YELLOWING FINISH



1 A501

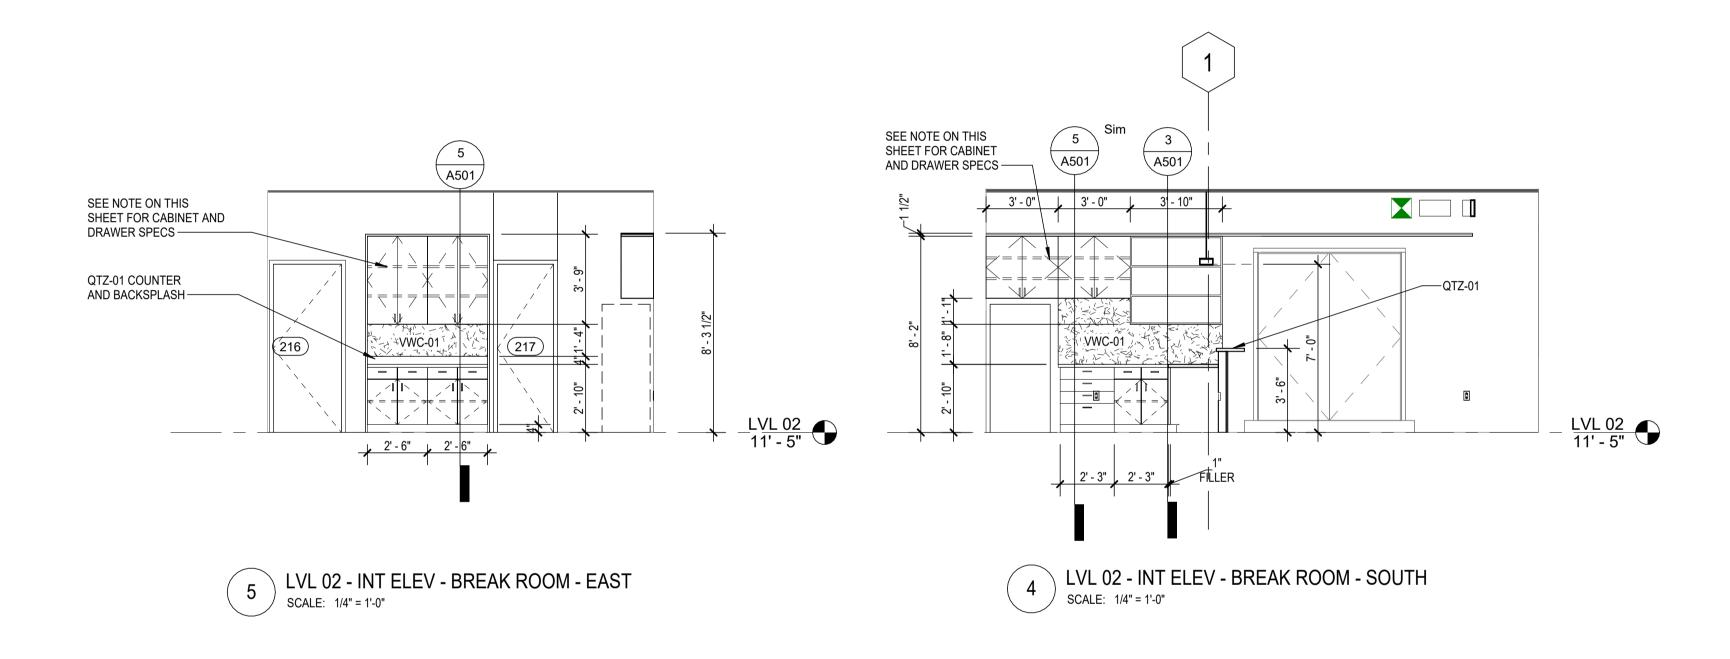A501


2 LVL 02 - ELEV - BREAK ROOM - EAST 02 SCALE: 1/4" = 1'-0"

- QTZ-01 COUNTER


- EXISTING STEP

-- PLAM-01

LVL 02 11' - 5"

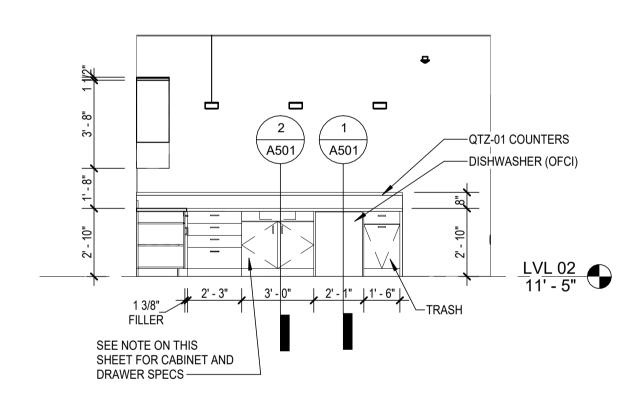

3 LVL 02 - INT ELEV - BREAK ROOM - WEST SCALE: 1/4" = 1'-0"

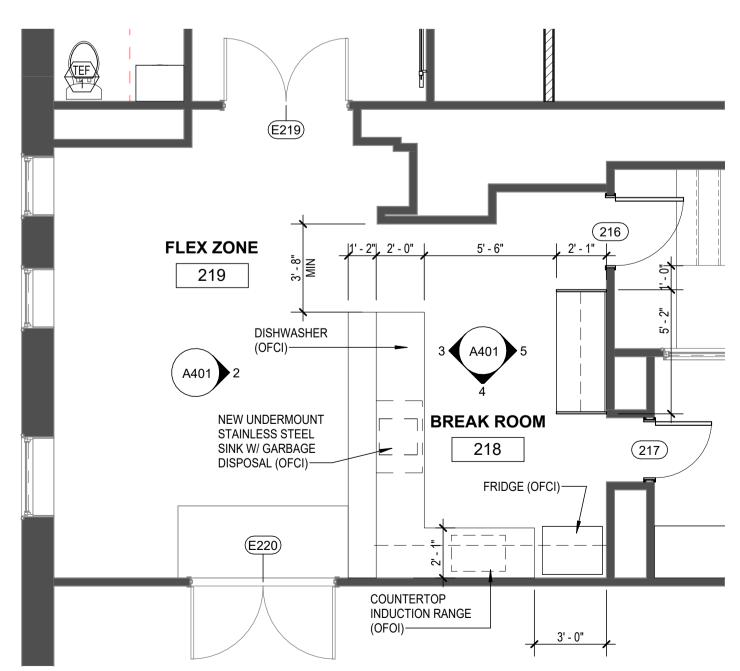

1 LVL 02 - ENLARGED PLAN - KITCHENETTE AND LOUNGE SCALE: 1/4" = 1'-0"

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REV DATE

CONSTRUCTION DOCUMENTS	1	06NOV2024
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LVL 02 BREAK ROOM

PROJECT NORTH

DWG No:






PROJECT No: 2407




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LVL 02 - RCP - CONFERENCE ROOM

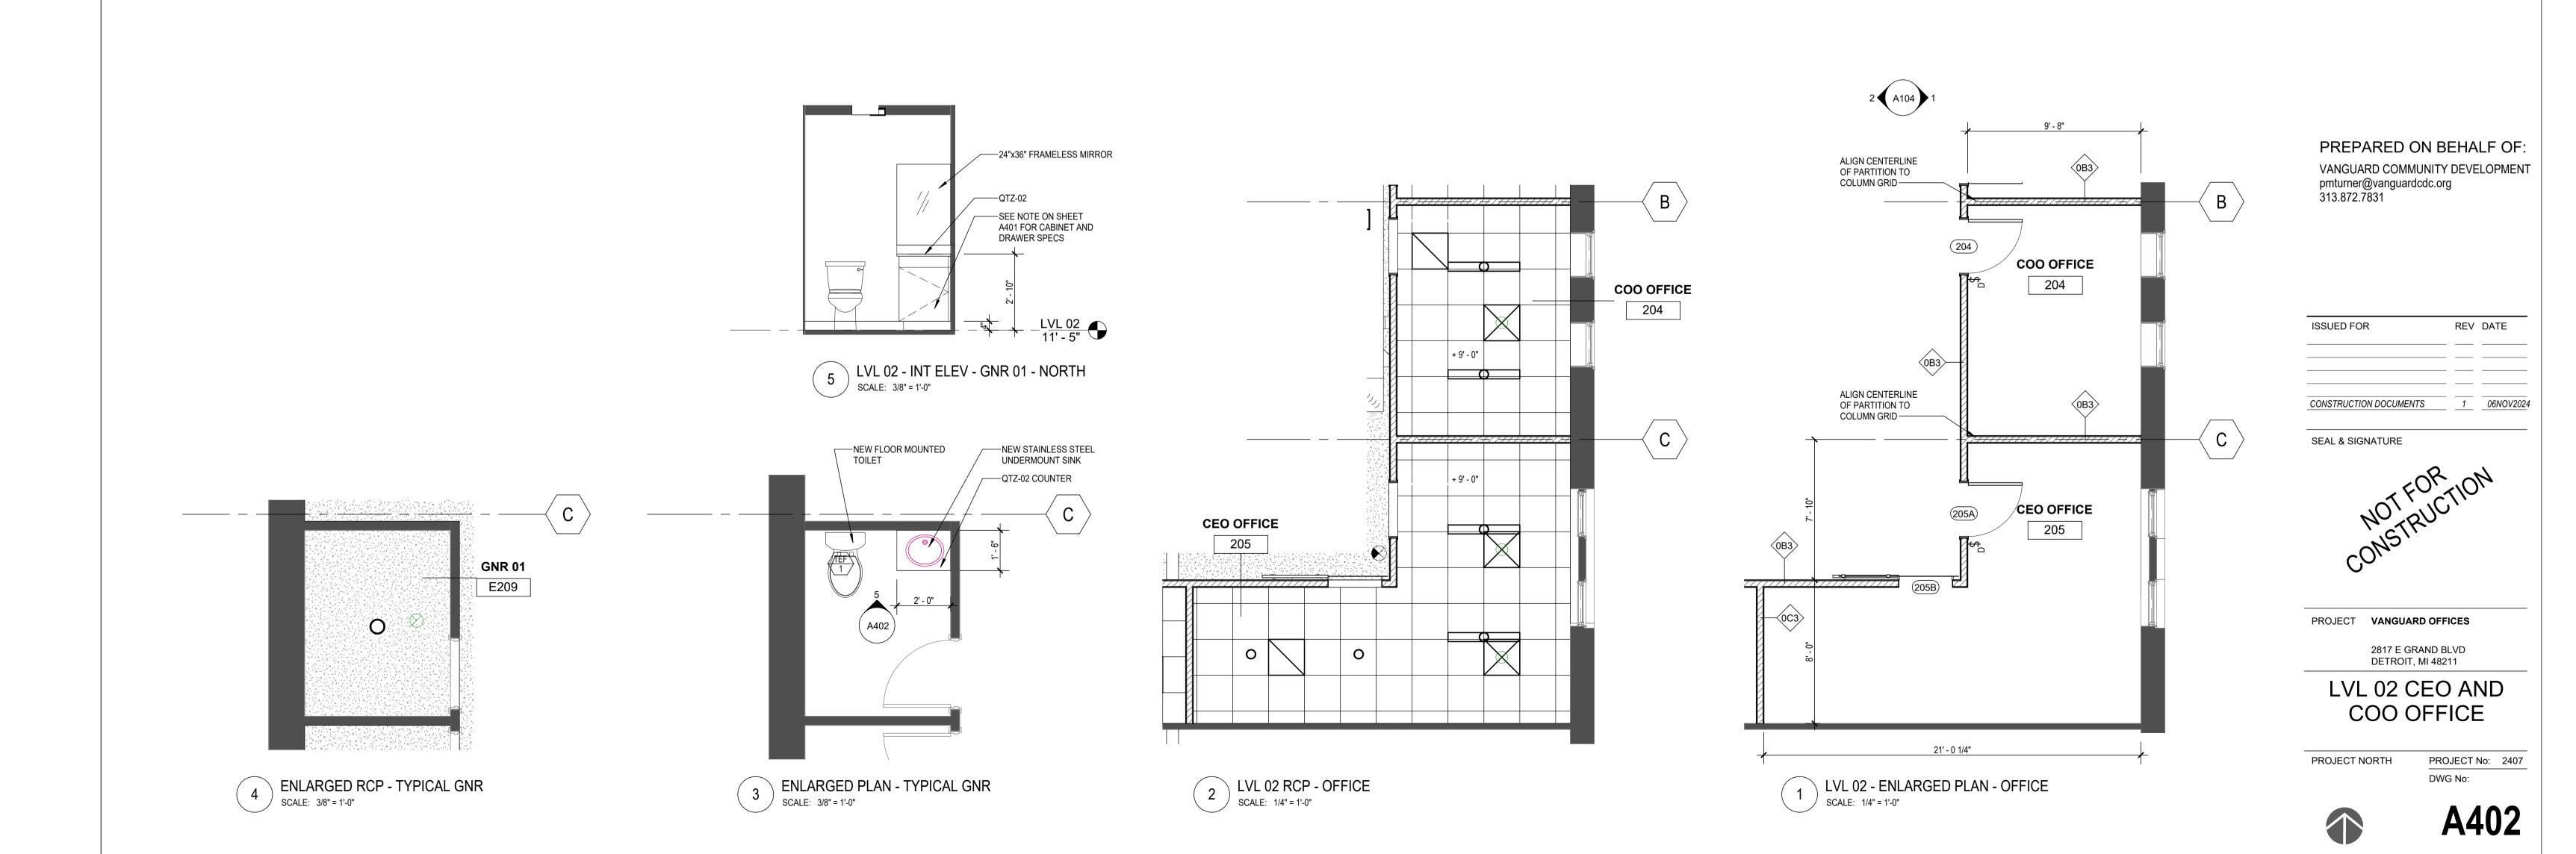) SCALE: 1/4" = 1'-0"

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CONSTRUCTION DOCUMENTS

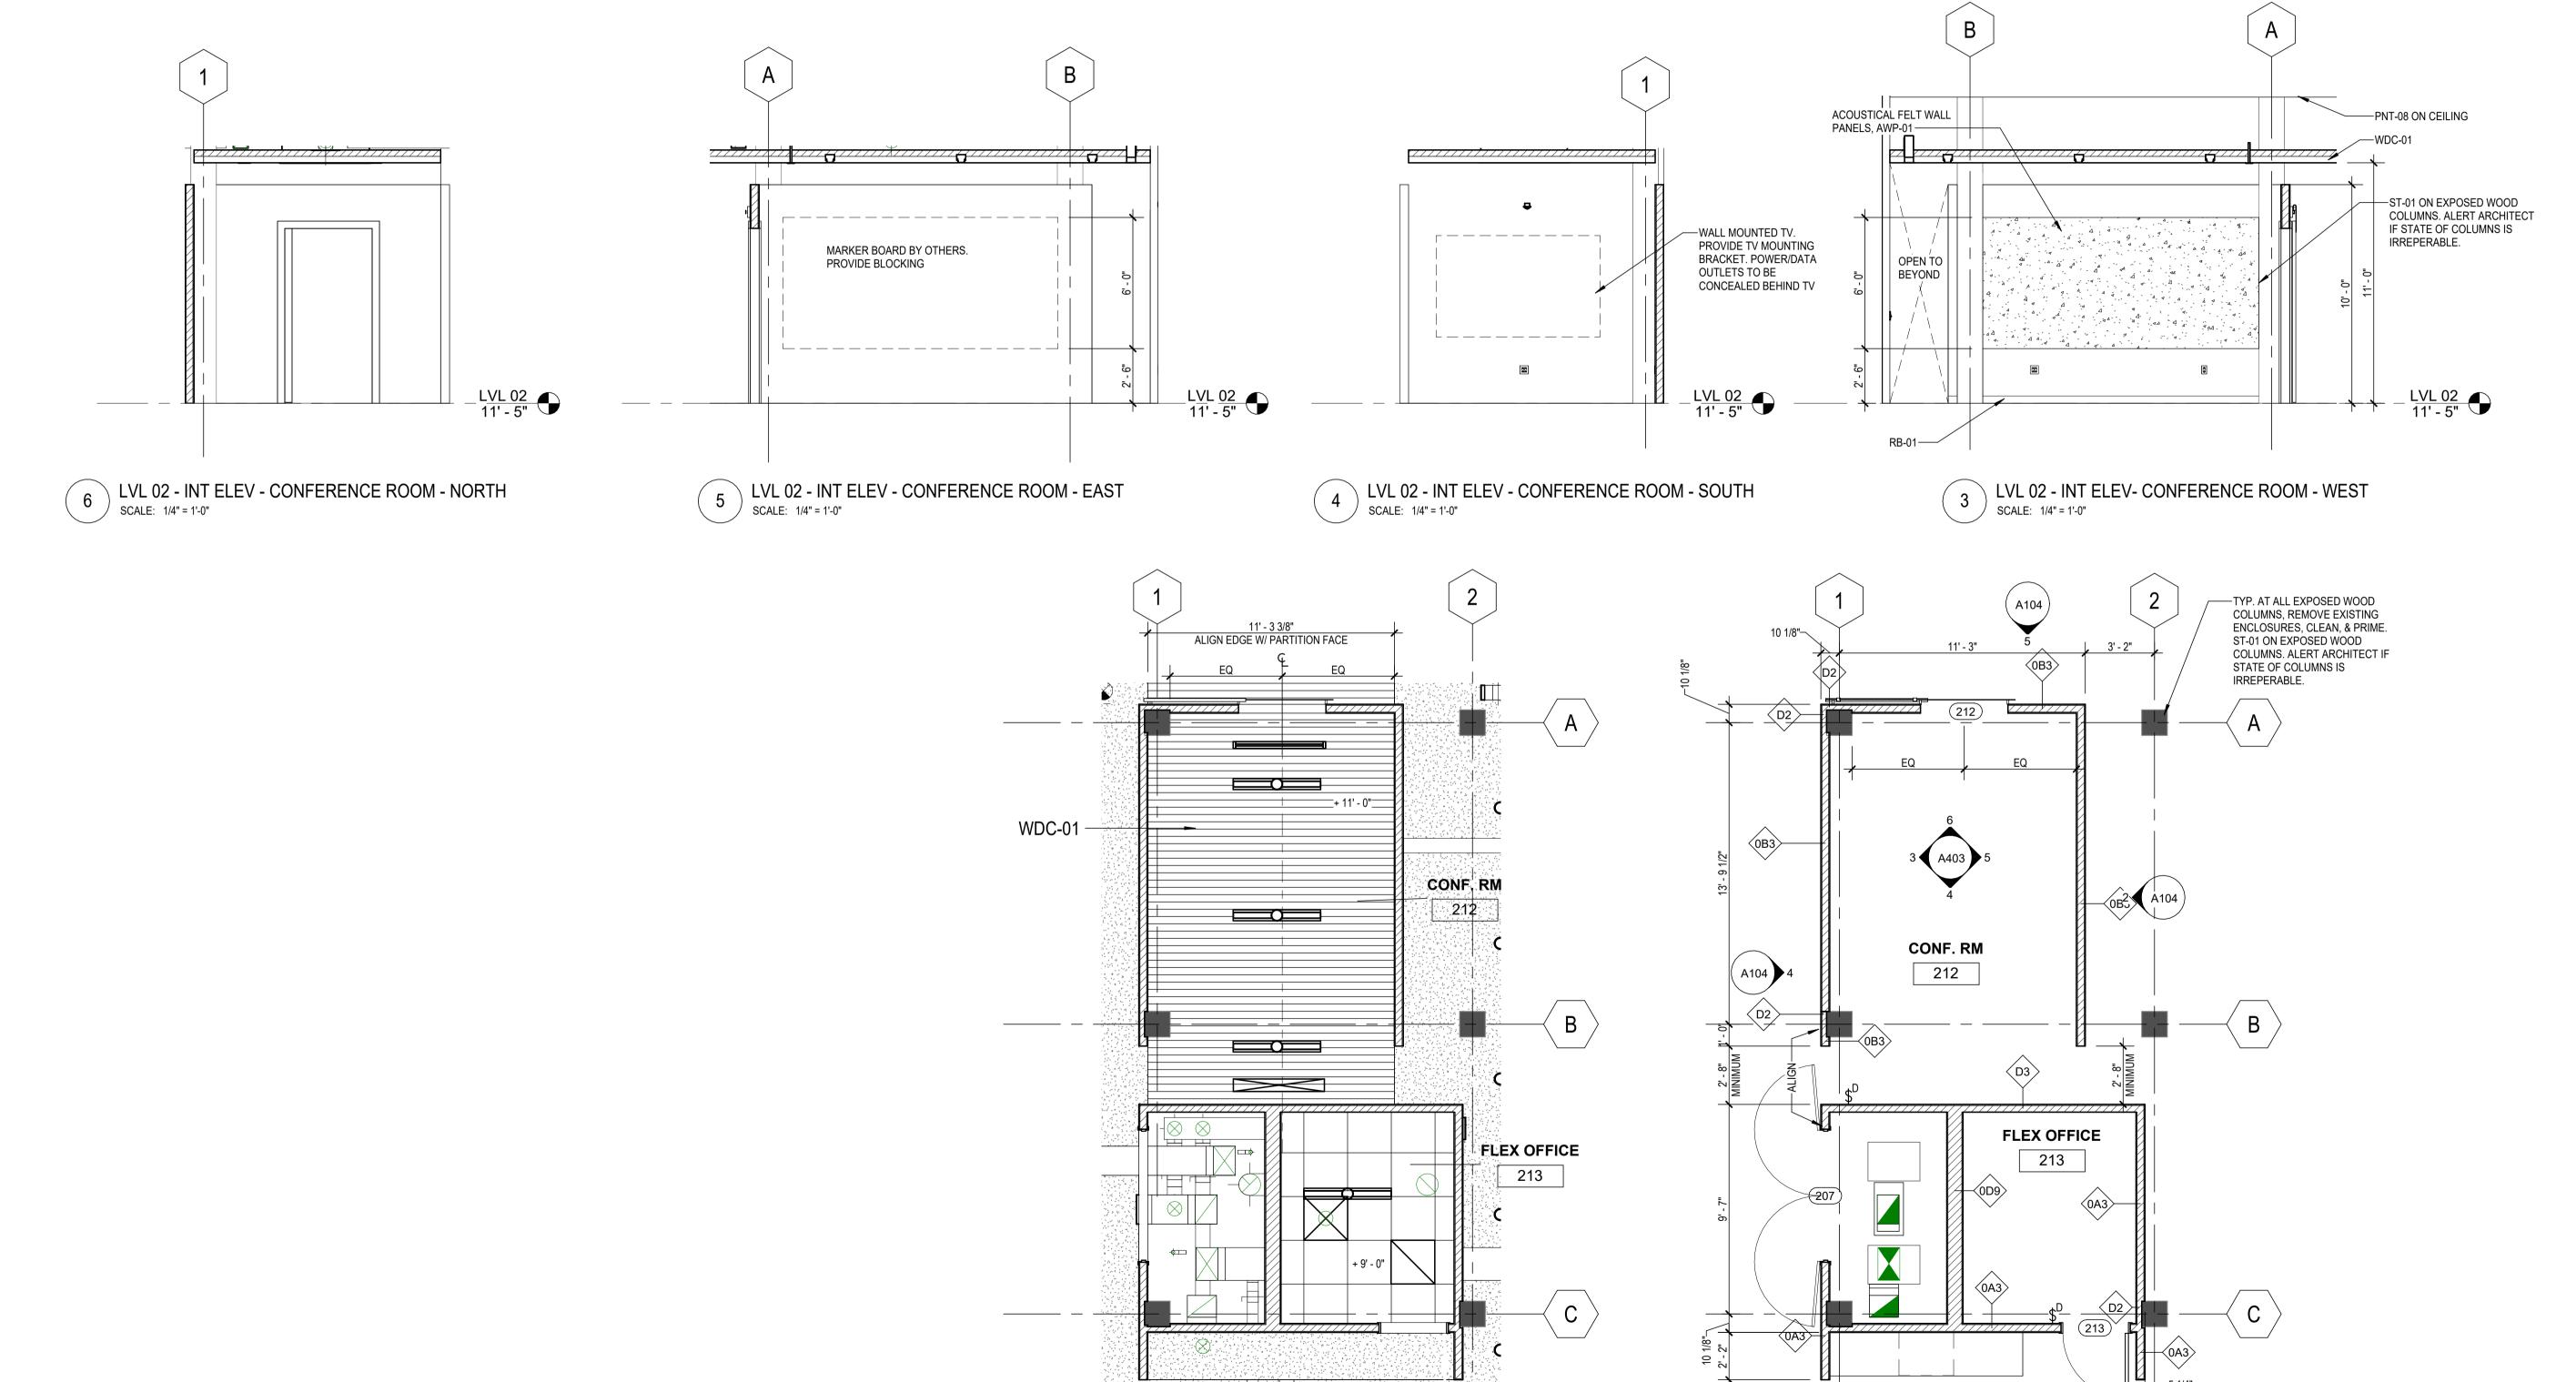

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2817 E GRAND BLVD DETROIT, MI 48211

LVL 02 MEETING ROOMS

PROJECT NORTH

(A104)


SCALE: 1/4" = 1'-0"

LVL 02 - ENLARGED PLAN - CONFERENCE





architecture advocacy art 3303 Wesson St Detroit, Michigan 48210 248.991.1457 laura@other-work.com

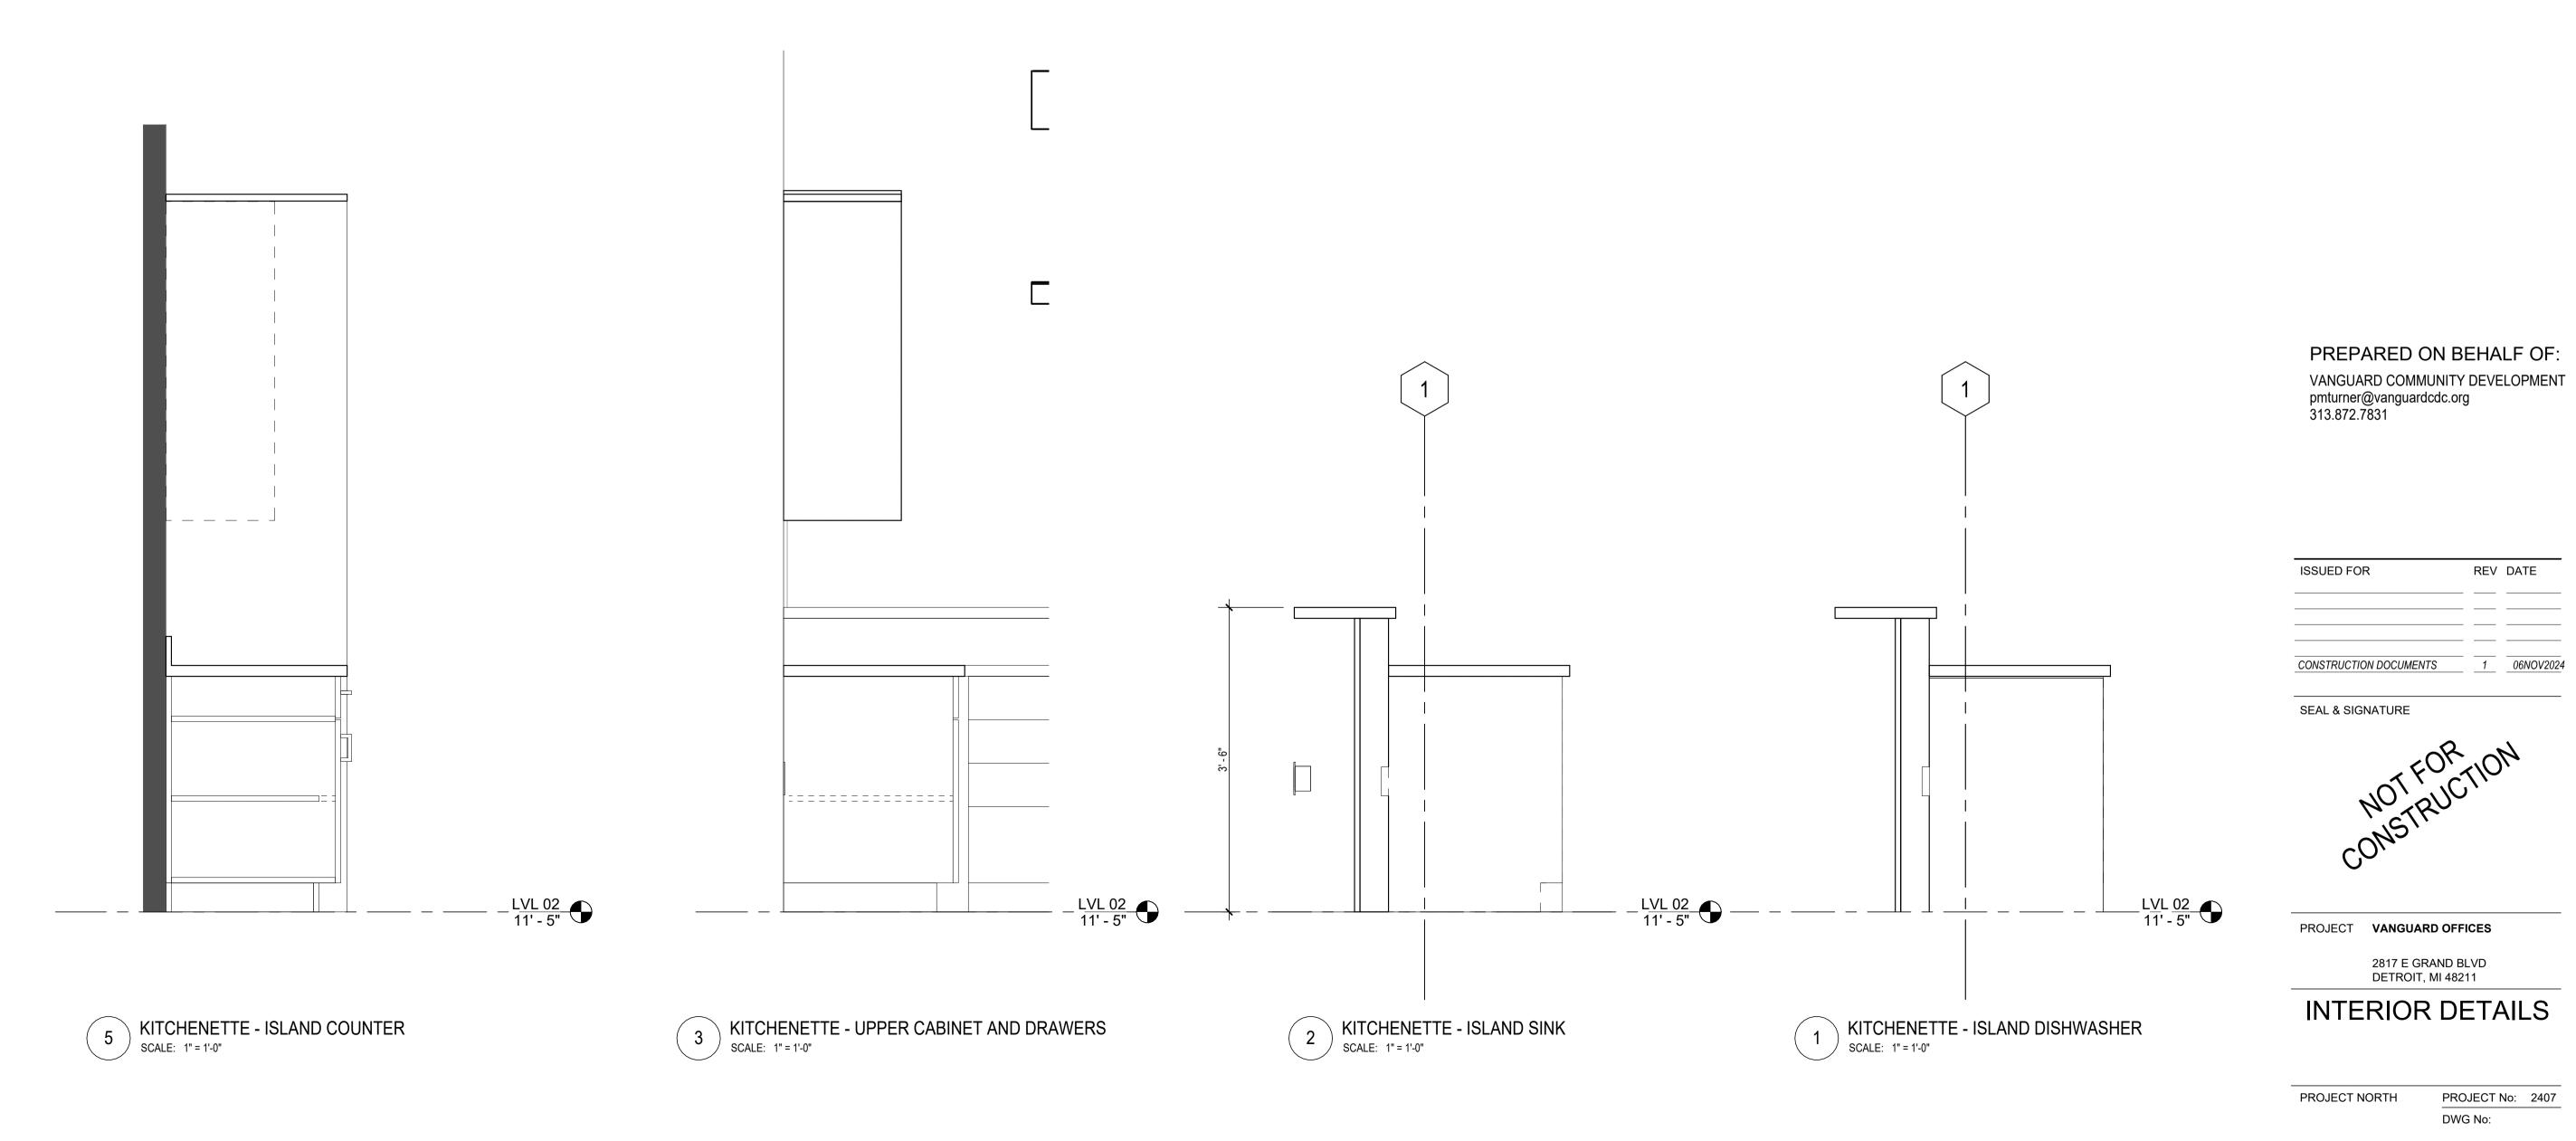



A501



MATERIALS AND FINISH NOTES

- 4. WHERE NOTED IN ROOM FINISH SCHEDULE, RESILIENT BASE TO BE COVED AT ALL LOCATIONS, INCLUDING COLUMNS.
- ADJACENT COUNTERTOP MATERIAL AND COLOR. FLOORING CONTRACTOR TO PROVIDE LAYOUT/INSTALLATION AND SEAMING DIAGRAM DRAWINGS FOR ALL FLOORING MATERIALS PRIOR TO
- CENTER OF DOOR, UNLESS OTHERWISE NOTED. WHERE FLOORING TRANSITIONS DO NOT OCCUR AT A DOOR, THE TRANSITION SHOULD ALIGN WITH A PARTITION.
- 8. ALL INTERIOR GLAZING TO BE CLEAR GLASS UNLESS OTHERWISE NOTED.
- 10. ALL INTERIOR DOOR FRAMES TO BE PAINTED PNT-5 UNLESS OTHERWISE NOTED.

1. FURNISH EXTRA MATERIALS, FROM THE SAME PRODUCT RUN. THAT MATCH PRODUCTS INSTALLED AND THAT ARE PACKAGED WITH PROTECTIVE COVERING FOR STORAGE AND IDENTIFIED WITH LABELS DESCRIBING CONTENTS. A. CARPET TILE: FULL-SIZE UNITS EQUAL TO FIVE (5) PERCENT OF AMOUNT INSTALLED FOR EACH TYPE INDICATED, BUT NOT LESS THAN 10 SQ. YD.

2. ALL INTERIOR GYPSUM WALLS, CEILINGS, AND SOFFITS TO BE PAINTED PNT-1 UNLESS OTHERWISE NOTED. 3. ALL DOORS TO BE WDV-1 UNLESS OTHERWISE NOTED.

5. ALL ARCHITECTURAL MILLWORK SUPPORTS TO MATCH

INSTALLATION. 7. ALL FLOORING TRANSITIONS TO OCCUR BENEATH AND AT

9. REFER TO DETAILS ON THIS SHEET FOR FLOOR

MANUFACTORER

SHAW CONTRACT

SHAW CONTRACT

JOHNSONITE/TARKETT

JOHNSONITE/TARKETT

CUTTING EDGE STONECRAFT

CUTTING EDGE STONECRAFT

SERIES NAME

FINISH / COLOR

TILE: WHITE. GRID: 15/16" WHITE

CLEAR COAT

REFER TO ARCHITECTURAL DRAWINGS

TRANSITION DETAILS.

11. REFER TO FINISH PLANS FOR CARPET DIRECTION INSTALL. INSTALL DIRECTIONS INDICATED SHOULD MATCH ARROWS MARKED ON BACK OF CARPET TILE.

TO MATCH WDV-01

ROBINS EGG BLUE

BROWN - WORKSTATIONS

PAINT COLOR FOR CEILINGS AT UNDERSIDE OF DECK

CLEAR FINISH ON ALL EXPOSED WOOD COLUMNS. PRIMER, LATEX, FOR INTERIOR WOOD: MPI #39

ANDREI: info@cestonecraft.com (248) 474-9999

> 55% recycled content; >ASTM E84-21A Class A OR GREATER; TVOC: <0.5 mg/m3; NRC > 0.7

YELLOW

PAINT COLOR FOR ALL EXISTING FIXTURES, PIPES, CONDUITS, ETC TO MATCH EXISTING CEILING PAINT

NUETRAL FRENCH GRAY - MEETING ROOMS/COPY

PREPARED ON BEHALF OF: VANGUARD COMMUNITY DEVELOPMENT pmturner@vanguardcdc.org 313.872.7831

ISSUED FOR	REV	DATE	
			_
			_

SEAL & SIGNATURE

CONSTRUCTION DOCUMENTS

Other Work

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PROJECT VANGUARD OFFICES

2817 E GRAND BLVD DETROIT, MI 48211

ROOM FINISH PLAN, SCHEDULE & **DETAILS**

PROJECT NORTH

A601

DWG No:

PROJECT No: 2407



							Door Schedule		
Mark	Width	Height	Door Material	Door Finish	Frame Material	FRAME FINISH	Description	Door Rating	NOTES
Level 1									
100	6' - 6"	7' - 0"	GALVAN IZED STEEL	I	GALVANIZ ED		OVERHEAD COILING SECURITY DOOR. VIF EXISTING DIMENSIONS OF STOREFRONT ENTRANCE		MOTOR OPERATED WITH BACK-UP POWER, EMERGENCY OPEN ALARM INPUT
101	3' - 0"	7' - 0"	НМ	PAINT	НМ	PAINT	FLUSH	60	EMERGENCY EGRESS HARDWARE
102	4' - 0"	7' - 0"	GALVAN IZED STEEL		GALVANIZ ED		OVERHEAD COILING SECURITY DOOR. VIF EXISTING DIMENSIONS OF ENTRANCE		MOTOR OPERATED WITH BACK-UP POWER, EMERGENCY OPEN ALARM INPUT
110	3' - 0"	7' - 0"	WD	WDV-01	WD	WDV-01	FLUSH	-	SOLID CORE WOOD DOOR
116A	3' - 0"	7' - 0"	НМ	PAINT	НМ	PAINT	FLUSH	60	EMERGENCY EGRESS HARDWARE
116B	2' - 10"	7' - 0"	НМ	PAINT	НМ	PAINT	FLUSH	60	
E100A	3' - 4"	6' - 10 1/4"	AL/GL	<by Categor y></by 					EXISTING DOORS GETTING NEW SECURITYAND EMERGENCY EGRESS HARDWARE - REFER TO SECURITY DRAWINGS
E100B	3' - 4"	6' - 8 1/4"	AL/GL	<by categor="" y=""></by>					EXISTING DOORS GETTING NEW SECURITYAND EMERGENCY EGRESS HARDWARE - REFER TO SECURITY DRAWINGS
E102A	3' - 6"	7' - 0"		EXISTIN G					EXISTING DOORS GETTING NEW SECURITYAND EMERGENCY EGRESS HARDWARE - REFER TO SECURITY DRAWINGS
E103	3' - 0"	7' - 0"		EXISTIN G					
E104	3' - 0"	7' - 0"		EXISTIN G					
E105	3' - 0"	7' - 0"		EXISTIN G					
E106	3' - 0"	7' - 0"		EXISTIN G					
E107 E108	3' - 0"	7' - 0"		EXISTIN G EXISTIN					
E109	3' - 0"	7' - 0"		G					EXISTING DOORS GETTING NEW SECURITYAND EMERGENCY
E111	2' - 6"	7' - 0"	WD	G					EGRESS HARDWARE - REFER TO SECURITY DRAWINGS
				G					
LVL 02									
200A	2' - 6"	7' - 0"		WDV-01		WDV-01	FLUSH	-	
201	3' - 0"	7' - 0"	HM	PAINT		PAINT	FLUSH	60	EMERGENCY EGRESS HARDWARE
202	3' - 0"	8' - 0"	WD	WDV-01		WDV-01	FLUSH	-	
203	2' - 8"	7' - 0"	WD	WDV-01		WDV-01	FLUSH	-	
204	3' - 0"	8' - 0"	WD	WDV-01		WDV-01	FLUSH	-	
205A	3' - 0"	8' - 0"	WD	WDV-01		WDV-01	FLUSH	-	
205B	3' - 0"	8' - 0"	WD	WDV-01		MAIDNAGA	Barn Door		
207	6' - 0"	8' - 0"	WD	WDV-01		WDV-01	DOUBLE DOOR FLUSH		
212	4' - 0"	8' - 0"	WD	WDV-01		\\/D\/ 01	Barn Door		
213	3' - 0"	8' - 0"	WD	WDV-01		WDV-01	FLUSH	-	
214	3' - 0"	8' - 0"	WD	WDV-01		D 4 15 17	Barn Door	00	EMEDOENOV FORFOO HARRINARE
216	2' - 10"	7' - 0"	HM	PAINT		PAINT	FLUSH	60	EMERGENCY EGRESS HARDWARE
217	2' - 4"	7' - 0"	WD	WDV-01		WDV-01	FLUSH	-	
E208	2' - 6"	7' - 0"	WD	EXISTIN G					
E209	2' - 6"	7' - 0"	WD	EXISTIN G					
E219	5' - 2"	7' - 0"		EXISTIN G					
E220	6' - 0"	7' - 0"		EXISTIN G					

Other Work

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PREPARED ON BEHALF OF: VANGUARD COMMUNITY DEVELOPMENT pmturner@vanguardcdc.org 313.872.7831

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CONCEDUCTION DOCUMENTO		00000
CONSTRUCTION DOCUMENTS	7	06NOV2

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PROJECT VANGUARD OFFICES

2817 E GRAND BLVD DETROIT, MI 48211

DOOR & WINDOW SCHEDULE & DETAILS

PROJECT NORTH





MECHANICAL GENERAL NOTES

NOTES APPLY TO ALL MECHANICAL DRAWINGS

- 1. EACH CONTRACTOR SHALL VISIT CONSTRUCTION SITE PRIOR TO BIDDING. EXAMINE SCOPE AND CONDITIONS OF OTHER CONTRACT WORK. EXAMINE EXISTING CONDITIONS AND ALL INTERFERENCES AND REQUIRED COORDINATION IN ORDER TO INCLUDE EFFECT OF SAID CONDITIONS IN THEIR BID. BID DRAWING ARE DIAGRAMMATIC AND DO NOT INDICATE ALL REQUIRED RELOCATIONS. OFFSETS, CHANGE IN ASPECT RATIOS, OR ROUTING CHANGES REQUIRED TO INTEGRATE WORK WITH ALL OTHER CONDITIONS OR TRADES. WORK INSTALLED BEFORE COORDINATING SO AS TO CAUSE INTERFERENCES WITH OTHER TRADES SHALL BE REMOVED AND REWORKED WITHOUT COST TO OWNER, COST OF PROVIDING SUCH RELOCATIONS, OFFSETS, SIZE, CHANGES, REROUTING, ETC. SHALL BE INCLUDED IN BID.
- 2. ALL WORK SHALL BE FURNISHED AND INSTALLED IN ACCORDANCE WITH BUILDING STANDARDS, ALL APPLICABLE CODES AND PER MANUFACTURER'S RECOMMENDATIONS.
- 3. BUILDING PLANS SHOWN ARE COMPILED FROM SOURCES BELIEVED TO BE ACCURATE. HOWEVER, THE INFORMATION SHOWN ON THESE PLANS IS SCHEMATIC AND CONTRACTOR SHALL BE RESPONSIBLE FOR ALL PROPER DIMENSIONS, SIZES, SYSTEM VOLTAGES, QUANTITIES, AND EXTENT OF WORK.
- 4. WITH THE APPROVAL OF THE ARCHITECT AND WITHOUT ADDITIONAL COST TO THE OWNER, MAKE MODIFICATIONS IN THE WORK. INCLUDING REROUTING AS REQUIRED BY INTERFERENCE WITH STRUCTURAL, GENERAL AND WORK OF OTHER TRADES FOR
- REFER TO THE ARCHITECTURAL DRAWINGS. FIELD CONDITIONS AND DETAILS FOR EXACT LOCATION OF PARTITIONS, RCP. DIMENSIONED ELEMENTS. CONTRACTOR TO COORDINATE THE EXACT LOCATION OF MECHANICAL EQUIPMENT WITH THE LOCATIONS OF LIGHT FIXTURES, PIPING, CONDUIT, AND OTHER CONSTRUCTION, TO ALLOW FOR PROPER ACCESS TO SERVICE
- 6. REFER TO ARCHITECTURAL DRAWINGS FOR LOCATIONS OF WALLS WHICH EXTEND TO STRUCTURE. EACH HVAC DUCT OR PIPE PENETRATION THRU THESE WALLS SHALL BE INSTALLED AS DETAILED. WHERE FLEXIBLE DUCT WOULD PENETRATE A WALL WHICH EXTENDS TO STRUCTURE, PROVIDE INSULATED RIGID DUCT EXTENDING 12 INCHES ON EITHER SIDE OF THE PARTITION
- 7. COORDINATE THE LOCATION OF DUCTWORK AND PIPING WITH OTHER TRADES AND PROVIDE OFFSETS IN DUCTWORK AND PIPING AS REQUIRED.
- 8. IT IS THE INTENT OF THESE DOCUMENTS TO ALLOW ALL CEILING CONSTRUCTION AND HEIGHTS TO BE AS SHOWN ON THE ARCHITECTURAL DRAWINGS. COORDINATE THE LOCATION OF DUCTWORK AND PIPING AND PROVIDE OFFSETS IN DUCTWORK AND PIPING AS REQUIRED TO MEET THIS INTENT.
- 9. CONTRACTOR SHALL FURNISH ALL MATERIALS, EQUIPMENT, AND LABOR REQUIRED FOR A COMPLETE WORKING AND COORDINATED SYSTEM. CUTTING AND PATCHING FOR THEIR WORK SHALL BE PERFORMED BY EACH TRADE CONTRACTOR
- 10. ARCHITECT SHALL HAVE FINAL APPROVAL OF ALL GRILLE, DIFFUSER, AND THERMOSTAT LOCATIONS. CONTRACTOR TO VERIFY AND COORDINATE WITH ARCHITECT TYPE OF CEILING TO DETERMINE DIFFUSER FRAME TYPE.
- 11. PROVIDE MANUAL DAMPER ON ALL LOW PRESSURE SUPPLY BRANCH TAKE-OFF OF DUCTWORK.
- 12. ALL DUCT SIZES SHOWN SHALL BE CLEAR INSIDE DIMENSIONS.
- 13. CONDUIT, PIPING, AND DUCTWORK SHALL BE INDEPENDENTLY SUPPORTED, AND EACH SUPPORT SHALL BE INDEPENDENT OF PARTITION AND CEILING SYSTEM SUPPORTS.
- 14. ALL EXHAUST AND SUPPLY LOUVERS SHALL BE NO CLOSER THAN 15'-0'.
- 15. ALL NEW PENETRATIONS SHALL CONFORM TO LOCAL JURISDICTION. CAULK ALL PENETRATIONS WITH FIRE RATING TO MATCH EXISTING WALL OR FLOOR. FINAL APPROVAL EXTERIOR GRATE BY OTHERS.
- 16. COORDINATE ALL WALL MOUNTED DEVICE LOCATIONS WITH ARCHITECTURAL INTERIOR ELEVATIONS.
- 17. REFER TO ARCHITECTURAL LIFE SAFETY PLANS FOR COORDINATION OF FIRE DAMPERS. THE DESIGN INTENT IS TO PROVIDE THE INDICATED DAMPERS IN ACCORDANCE WITH REQUIREMENTS OF THE 2018 INTERNATIONAL BUILDING CODE AND 2019 CHICAGO BUILDING CODE. THE CONTRACTOR SHALL PROVIDE ANY ADDITIONAL LIFE SAFETY DAMPERS, INCLUDING FIRE ALARM CONTROL WIRING AND MONITORING REQUIRED BY THE IBC AND LOCAL ORDINANCES AND CODE INTERPRETATIONS.
- 18. ANY DEVIATIONS FROM SCHEDULED EQUIPMENT RESULTING IN ADDITIONAL COST DUE TO THE LACK OF COORDINATION WITH DIMENSIONS AND WEIGHTS WILL BE THE RESPONSIBILITY OF THE CONTRACTOR.
- 19. ALL WORK SHALL BE SCHEDULED AND PERFORMED IN STRICT COORDINATION WITH ARCHITECTURAL PHASING PLANS AND
- 20. PROVISIONS SHALL BE MADE BY THE CONTRACTOR TO PREVENT DISRUPTING ADJACENT AREAS OF THE PHASE IN WHICH WORK IS BEING PERFORMED
- 21. ALL COPPER TUBING MAY BE TYPE ACR OR TYPE K UNLESS THE PRESSURE EXCEEDS THE RATED CAPACITY OF ACR TUBING. ALL CONNECTIONS AND DEVICES TO BE BRAZED.
- 22. PROVIDE PLENUM MOUNTED HUMIDIFIER FOR THE FURNACE COMPLETE WITH WATER CONNECTION, DRAIN PIPE AND FLOAT
- 23. PROVIDE COMPLETE GAS-FIRED FURNACE SYSTEMS INCLUDING D-X COILS, CONDENSING UNITS, PLENUMS, HUMIDIFIERS, FILTERS, DUCTWORK, REGISTERS AND TEMPERATURE CONTROL SYSTEM.
- 24. 25. PROVIDE NEW GAS PIPING AND CONNECTION TO ALL GAS-FIRED EQUIPMENT WITH SHUT-OFF VALVE. GAS PIPING SHALL BE SCHEDULE 40 BLACK STEEL PIPE.

ABBREVIATIONS								
SYMBOL	DESCRIPTION							
CFM	CUBIC FEET PER MINUTE							
CFM	CUBIC FEET PER MINUTE							
EA	EXHAUST AIR							
RA	RETURN AIR							
EF	EXHAUST FAN							
Т	THERMOSTAT							
TEF	TOILET EXHAUST FAN							
FE	FLUE EXHAUST							
CI	COMBUSTION AIR INTAKE							

MECHANICAL SYMBOLS

S	CEILING SUPPLY
S	FLOOR SUPPLY
R	CEILING RETURN
E	RECTANGULAR EXHAUST
-	

				2021 IMC V	ENTILATION SCH	EDULE						
ROOM NUMBER	SPACE NAME	AZ FLOOR AREA (FT²)	OCCUPANCY CATEGORY	OCCUPANT DENSITY (#/1000 ft²)	RP PEOPLE OA RATE (CFM/PPL)	RA AREA OA RATE (CFM/FT²)	#OF PEOPLE PER CODE	PEOPLE OUTDOOR AIRFLOW (CFM)	AREA OUTDOOR AIRFLOW (cfm)	E _Z ZONE AIR DISTRUBUTION EFFECTIVENESS	V _{oz} ZONE OUTDOOR AIRFLOW (CFM)	CODE REQUIRED EXHAUST AIRFLOW CFM
200	ARRIVAL	270	MAIN ENTRY LOBBY	10	5	0.06	3	14	16	0.8	37	
201	EXISTING STAIRS	155		30	5	0.06	5	23	9	0.8	41	
202	CFO OFFICE	120	OFFICE	5	5	0.06	1	3	7	0.8	13	
203	CFO- STORAGE	55	STORAGE ROOM	_	_	0.12	_	_	7	0.8	8	
204	COO OFFICE	120	OFFICE	5	5	0.06	1	3	7	0.8	13	
205	CEO OFFICE	205	OFFICE	5	5	0.06	1	5	12	0.8	22	
207	MECH ROOM	100	STORAGE ROOM	_	_	0.12	_	_	12	0.8	15	
208	GNR 02	45	TOILET ROOMS	_	_	_	_	_	_	_	_	50
209	GNR 01	40	TOILET ROOMS	_	_	_	_	_	_	_	_	50
210	WORKSTATION	225	OFFICE	5	5	0.06	1	6	14	0.8	24	
211	LIBRARY	140	LIBRARY	10	5	0.06	1	7	8	0.8	19	
212	CONFRENCE ROOM	240	CONFRENCE ROOM	50	5	0.06	12	60	14	0.8	93	
213	FLEX OFFICE	100	CONFRENCE ROOM	50	5	0.06	5	25	6	0.8	39	
214	PHONE ROOM	45	TELEPHONE/ DATA ENTRY	60	5	0.06	3	14	3	0.8	20	
216	EXISTING STAIRS	185		_	_	0.12	_	_	_	_	_	
217	GNR	75	TOILET ROOMS	_	_	_	_	_	_	_	_	50
218	BREAK ROOM	145	BREAK ROOM	25	5	0.06	4	18	9	0.8	31	
219	FLEX ZONE	260	MEETING	50	5	0.06	13	65	16	0.8	97	

									ENE	RGY RECO	VERY WHE	ELS								
					SUPPLY AIR		OUTSI	DE AIR	SUPP	LY AIR	RETUI	RN AIR	TOTAL	TOTAL	EL	ECTRICAL DA	TA	WEIGHT		
TAG	NO	LOCATION	SERVICE	CFM	PRESSURE DROP (inWC)	AIR PRESSURE DROP (inWC)	SUMMER DB/WB TEMP (°F)	WINTER DB/WB TEMP (°F)	SUMMER DB/WB TEMP (°F)	WINTER DB/WB TEMP (°F)	SUMMER DB/WB TEMP (°F)		WHEEL EFF. SUMMER (%)		MCA	MOCP	V/PH/HZ	WEIGHT (LBS)	MANUFACTURER	MODEL
ERV	1	LVL 02	LVL 02	550	0.5	0.5	90.7/73.4	0/0	83.2/68.9	31.5/27.9	75/62.4	72/55.7	61.6	76.1	11.1	15	208/1/60	213	RENEWAIRE	HE10IN

						EXHAU	IST FAN SC	HEDULE							
TA	∖ G	LOCATION	FAN TYPE	QTY	CFM	DUCT	RPM		ELECTRIC	CAL DATA		UNIT WEIGHT	MANUFACTURER	MODEL	REMARKS
ABBR.	#	200/111011	1744 111 2	QTT	OI W	SIZE (IN)	TXI IVI	AMPS	VOLTS	PH	HZ	(LBS)	WINTOTACTORER	WOBLE	TALIVII ATAO
TEF	1	BATHROOM	CEILING MOUNTED -DIRECT DRIVE	1	50	6"	800	0.1	115	1	60	10	PANASONIC	FV-0511VK2	1,2,3
1 PROVIDE	ELECTRIC	AL DISCONNECT.													•

										ı	FURNACE	SCHEDULE													
						UNIT	DI	IMENSIONS (IN)		F	AN			COOLING				HEATING				ELECT	TRICAL	
EQUIPMENT TAG	LOCATION	AREA SERVED	SYSTEM TYPE	MANUFACTURER	MODEL	WEIGHT (LBS)	HEIGHT	DEPTH	WIDTH	CFM	DRIVE	НР	RPM	МВН	E.S.P. (IN)	AFUE	INPUT (BTU/HR)	OUTPUT	STAGES	ΔΤ	E.S.P. (IN)	BREAKER SIZE	AMPS	PHASE	VOLTS
(E)E 1	CEE DI ANC	CEE DI ANG	NATURAL	COODMAN	CKCOOOOACXAC	450	25"	20"	47.5"	4500	4	1/0	200 4200	40	0.5	060/	00.000	00.000	ONE	25.65	0.5	4.5	40.0	4	445

2 PROVIDE GRILLE EXHAUST FAN WITH VARIABLE SPEED MOTOR

Ī											CONDEN	ISING UNIT	SCHEDULE										
								UNIT	DI	MENSIONS (N)		COMPRESSOR					COOLING			ELEC.	TRICAL	
	EQUIPMENT TAG	LOCATION	UNIT SERVED	MANUFACTURER	MODEL	SEER	EER	WEIGHT (LBS)	HEIGHT	DEPTH	WIDTH	QUANTITY	TYPE	REFRIGER	мото	R	TONS		OUTDOOR	MCA	PHASE	BREAKER	VOLTS
								(LBO)						ANT TYPE	HP	RPM		EAT (°F)	EAT (°F)			SIZE	
	CU-1	ROOF	F-1	GOODMAN	GSXN3N4810	13.5	13	222	35 3/16"	35 3/16"	35 3/16"	1	SINGLE STATGE SCROLL	R410A	0.50	800	4	80/67	95	25	1	40	208
	CU-2	ROOF	F-2	CARRIER	24ACB36	16.5	13	222	35 3/16"	31 3/16"	31 3/16"	1	ULTRATECH 2-STAGE SCROLL	PURON R410A	0.20	800	3	80/67	95	22	1	35	208

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TYPE	FRAME MOUNTING	FRAME SIZE	NECK SIZE	DAMPER	SLOT	MANUFAC TURER	MODEL	REMARKS
SUPPLY	0511 1110	24" X 24"	6"	-	-	TITUS	OMNI	1,2
SUPPLY		24" X 24"	8"	-	-	TITUS	OMNI	1,2
RETURN		24" X 24"	22"X22"	-	-	TITUS	PAS	1,2
SUPPLY	DUOT	8" X 8"	8" X 8"	OBD	-	TITUS	300RL	1,2
RETURN		16" X 12"	16" X 12"	OBD	-	TITUS	350RL	1,2
RETURN		12" X 12"	16" X 12"	OBD	-	TITUS	350RL	1,2
SUPPLY	CEILING	48"X 3"	8"	-	1	TITUS	ML-39	1.2,3
EXHAUST	MOUNTED	48"X 3"	-	-	1	TITUS	MLR-39	1.2
	SUPPLY RETURN SUPPLY RETURN RETURN SUPPLY	SUPPLY SUPPLY RETURN RETURN RETURN RETURN SUPPLY RETURN RETURN SUPPLY CEILING MOUNTED EXHAUST	CEILING 24" X 24" 24" X	SUPPLY CEILING MOUNTED 24" X 24" 6" 24" X 24" 8" 24" X 24" 22" X 22" 8" X 24" 22" X 22" 8" X 8" 8" X 8" 8" X 8" 8" X 8" 16" X 12" 16" X 12"	SUPPLY CEILING MOUNTED 24" X 24" 6" -	24" X 24" 6" - -	SUPPLY CEILING MOUNTED 24" X 24" 6" -	SUPPLY CEILING MOUNTED 24" X 24" 6" -

2 SEE DRAWING FOR SIZES AND AIRFLOWS 3 PROVIDE WITH PATTERN CONTROLLER

ISSUED FOR	REV	DATE
CONSTRUCTION DOCUMENT		06NOV2024
		-
SEAL & SIGNATURE		



PROJECT VANGUARD OFFICES 2817 E GRAND BLVD


> **MECHANICAL LEGEND AND GENERAL NOTES**


DETROIT, MI 48211


PROJECT No: 2407 PROJECT NORTH DWG No:



M001

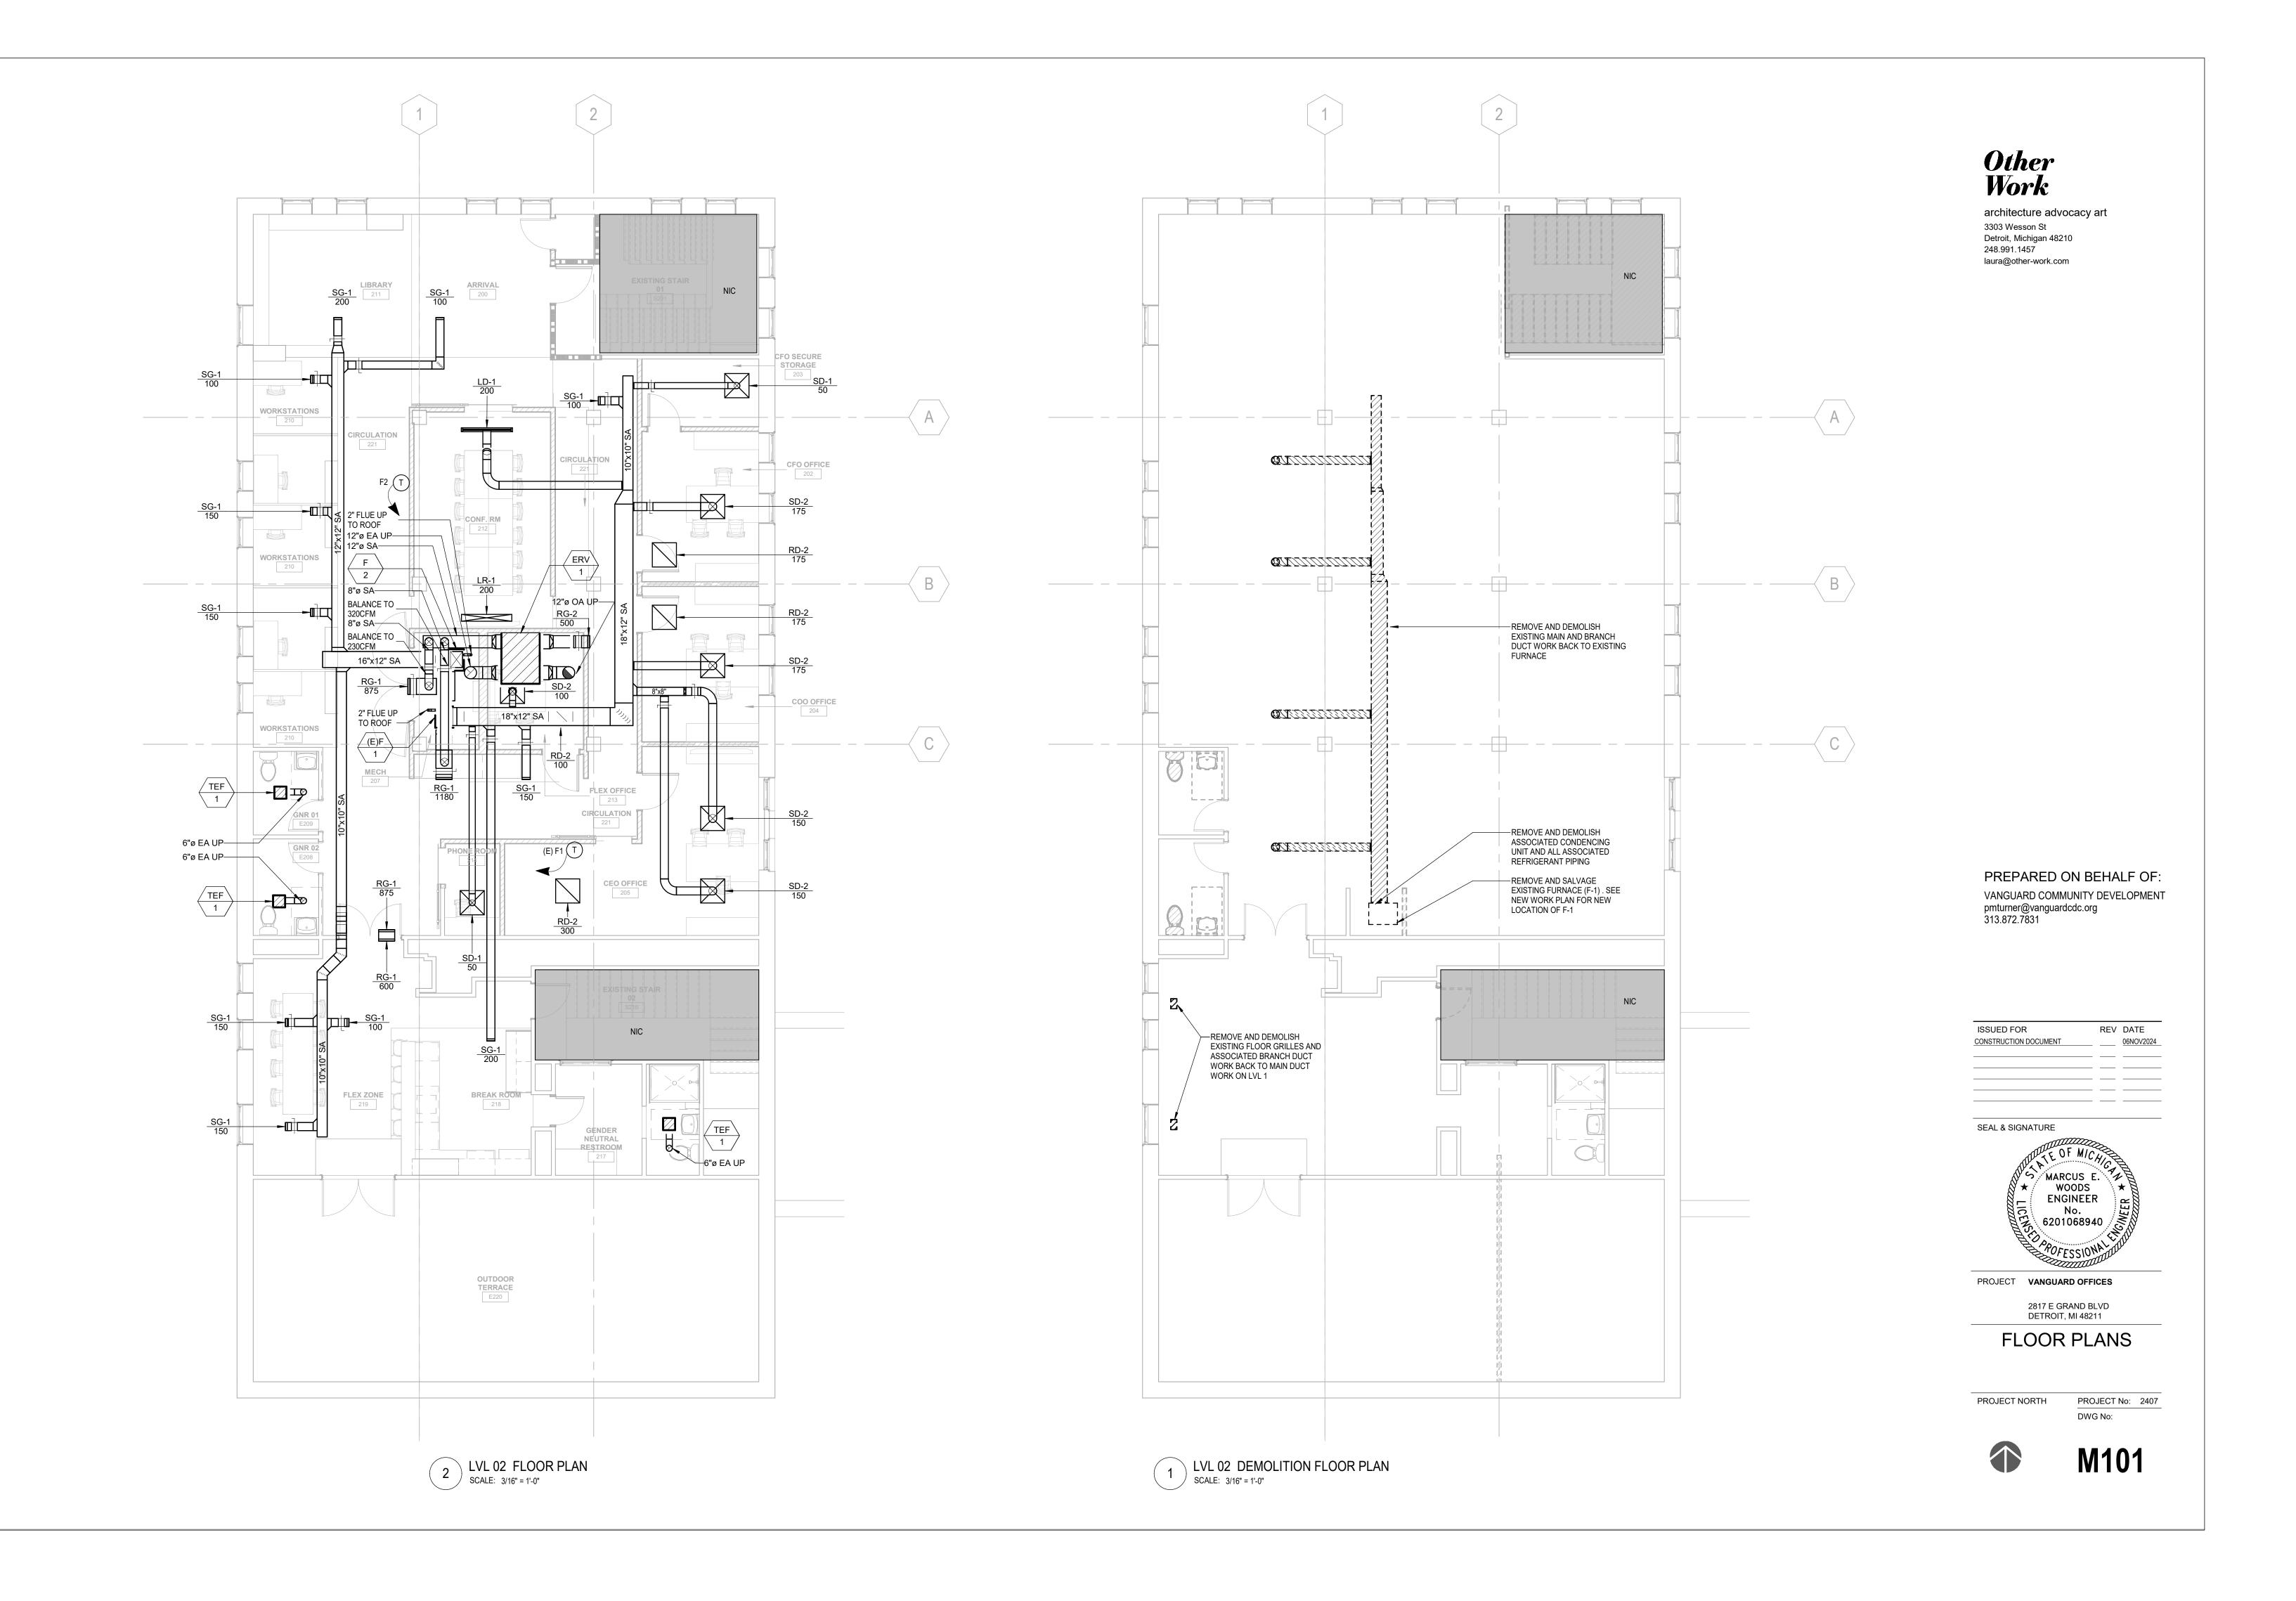

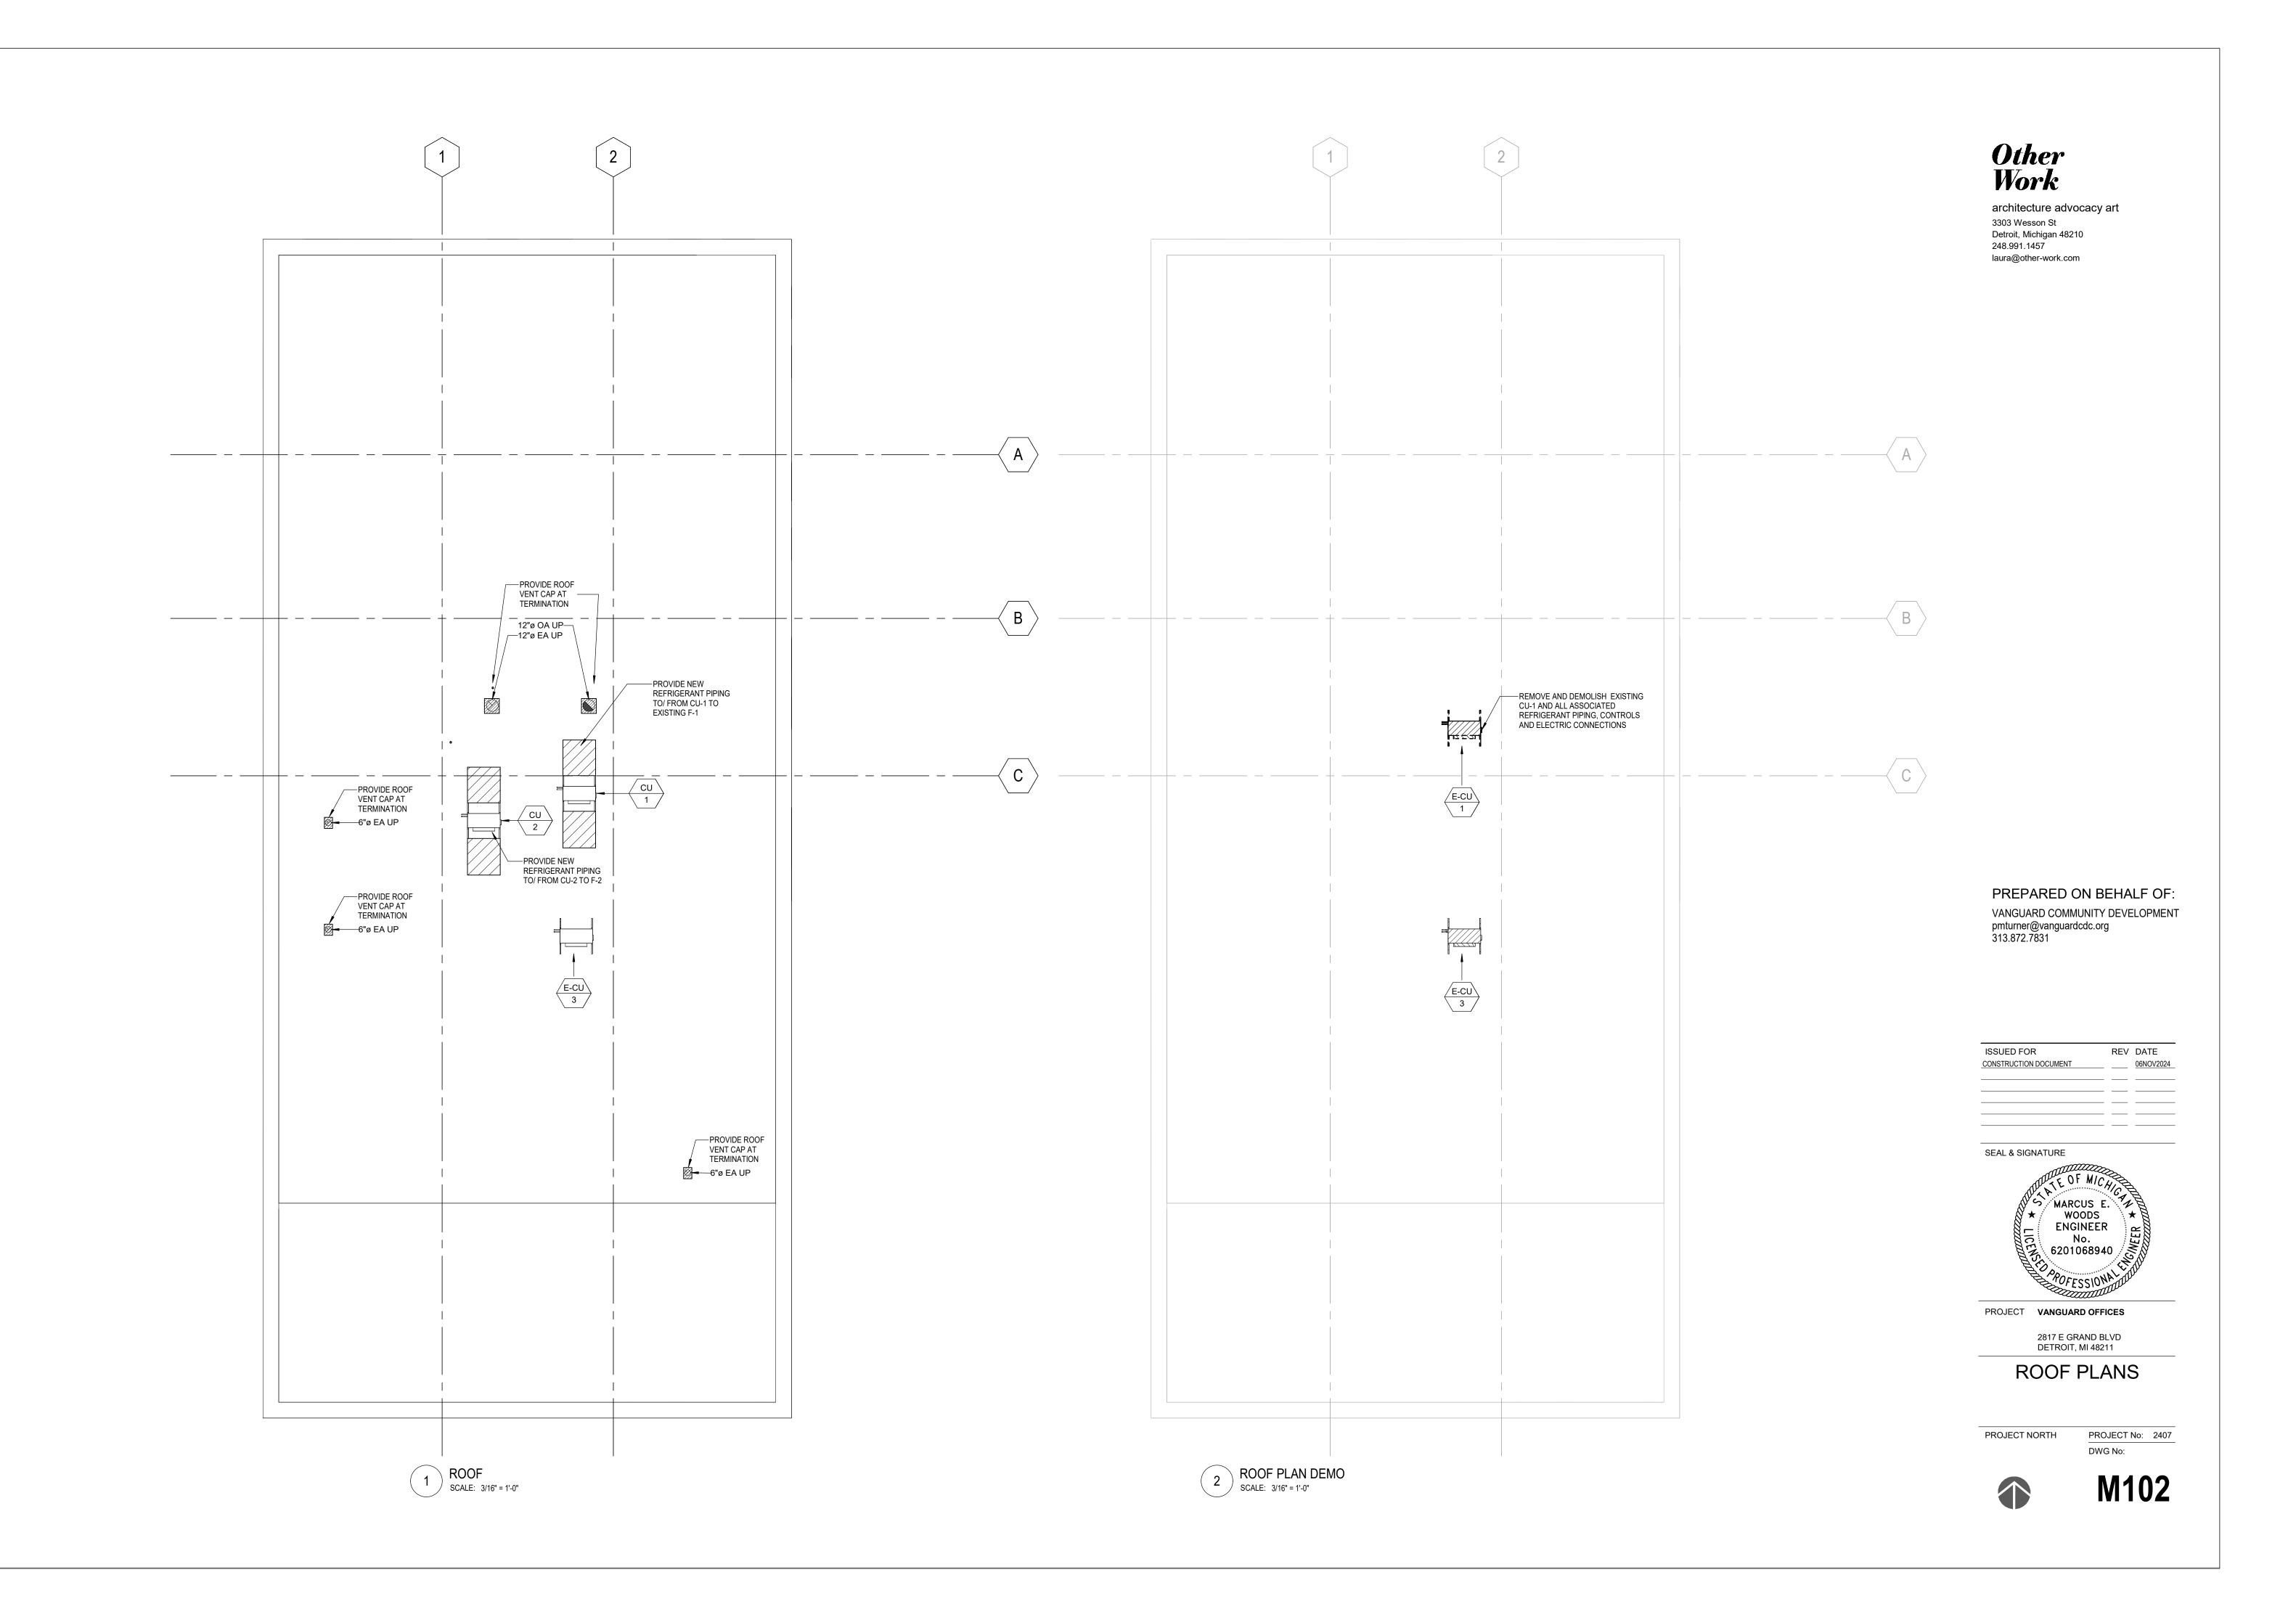


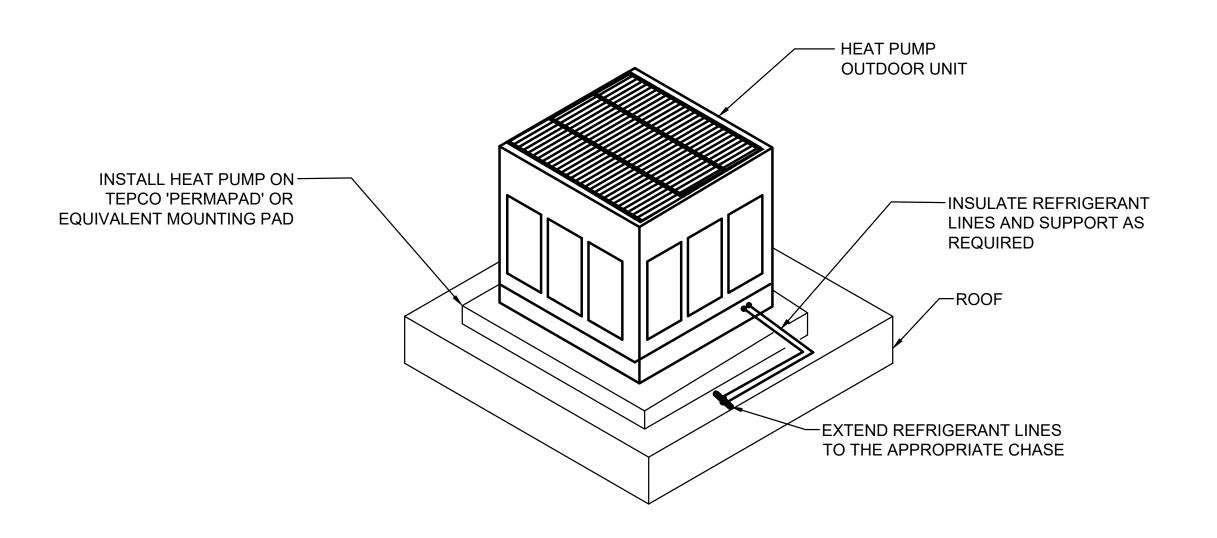


NOTE:

IT IS THE INTENT OF THIS DETAIL THAT THE CONTRACTOR PROPERLY INSTALL THE OUTDOOR UNIT TO COMPLY WITH ALL SEISMIC DESIGN CONSTRAINTS OF THE IBC AND ASCE 7-05.

$\frac{\text{CONDENSING UNIT DETAIL}}{\text{NTS}}$

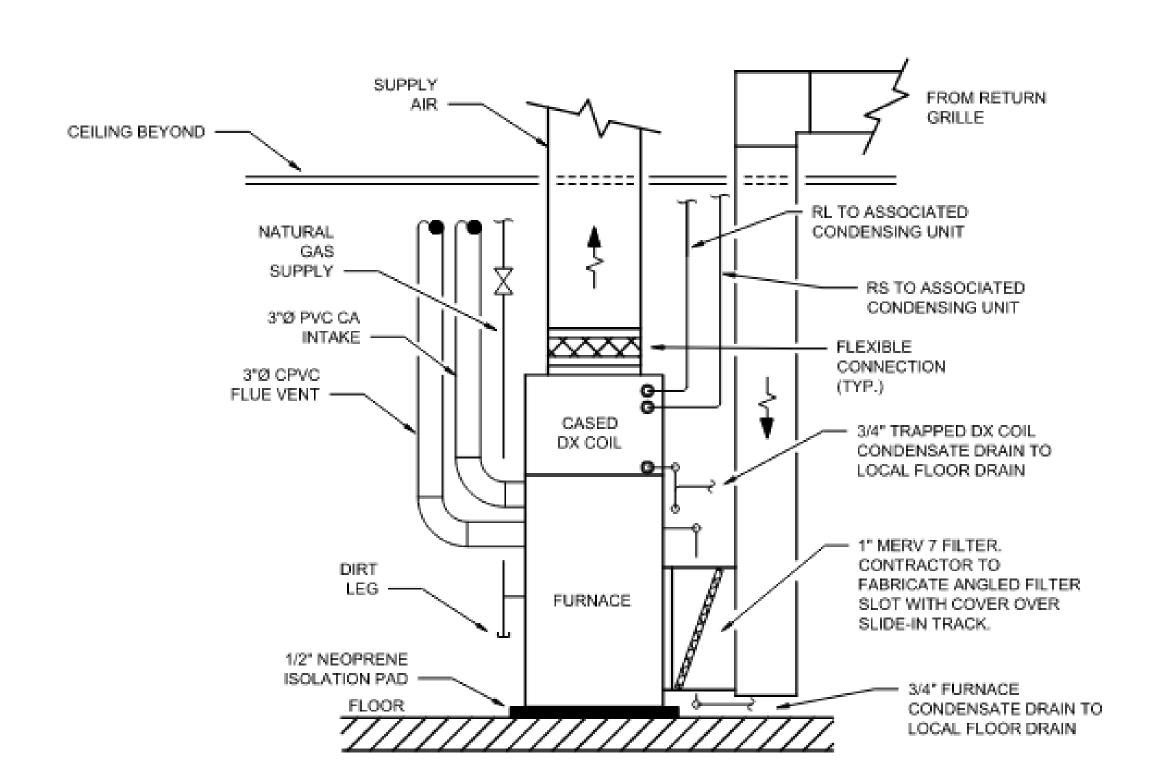

4 FLOOR MOUNTED FURNACE DETAIL NTS

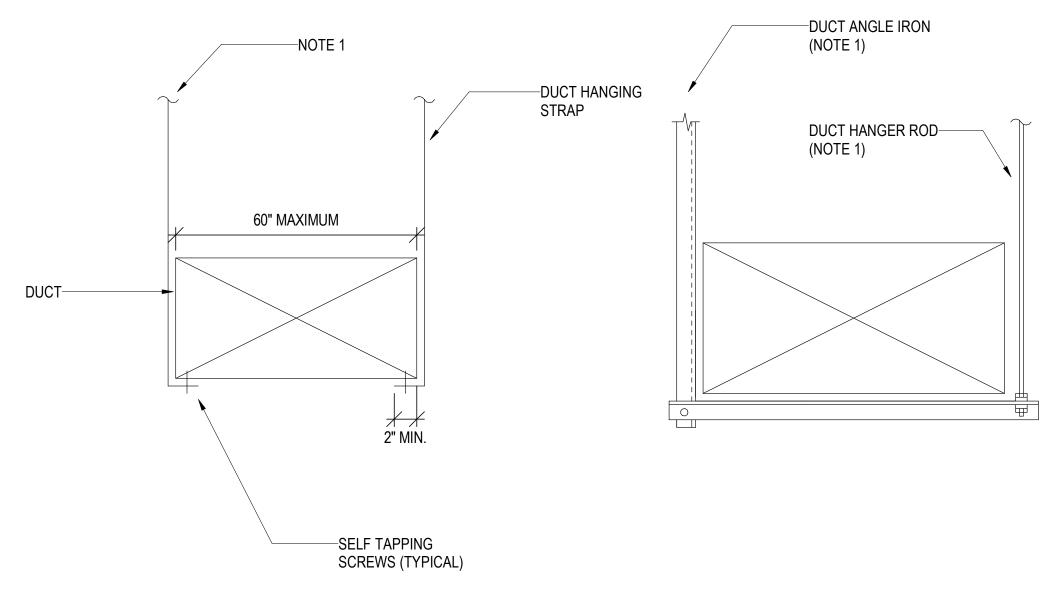

NOTES:


1. FOR HANGER SIZE AND SPACING, REFER TO CURRENT SMACNA HVAC DUCT CONSTRUCTION STANDARDS TABLE 5-1.

2. FOR UPPER ATTACHMENT TO BUILDING, SEE SMACNA HVAC DUCT CONSTRUCTION STANDARDS FIGURES 5-1 AND 5-2. OBTAIN SPECIFIC BUILDING STRUCTURAL ENGINEER APPROVAL FOR ALL METHODS OF ATTACHMENT.

3. FOR BRACING AND OTHER SEISMIC REQUIREMENTS, REFER TO GUIDELINES FOR SEISMIC RESTRAINS OF MECHANICAL SYSTEMS AND PLUMBING PIPING SYSTEMS PUBLISHED BY SMACNA.

4. CONTRACTOR SHALL SUBMIT ALL DUCT HANGER, SUPPORT AND SEISMIC DETAILS FOR REVIEW BY ENGINEER.

$\frac{1}{1} \frac{\text{RECTANGULAR DUCT SUPPORT}}{\text{NTS}}$

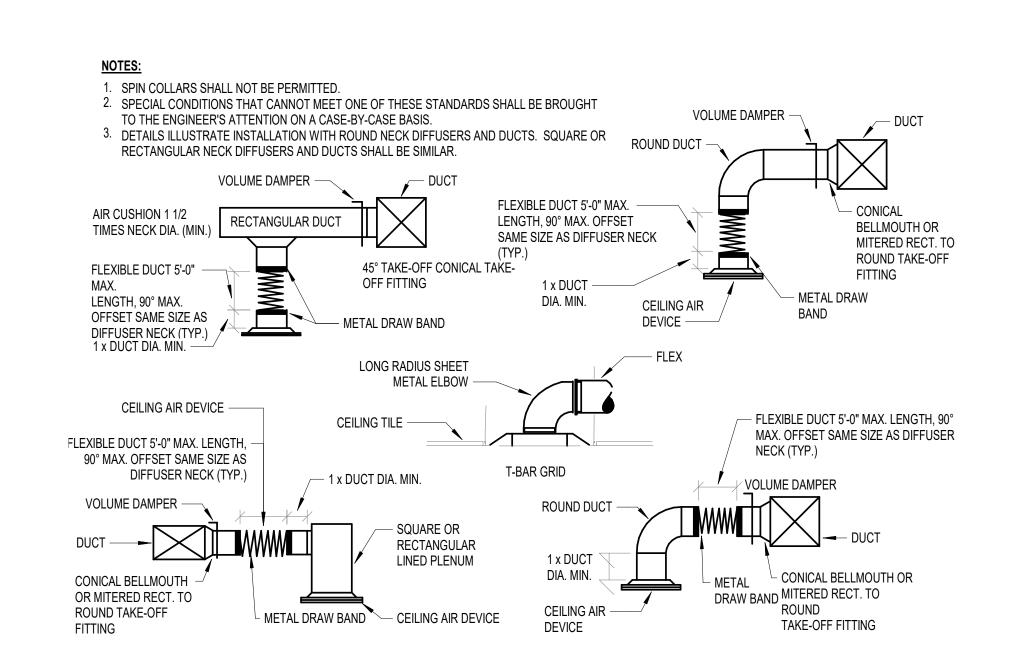

2 TYPICAL AIR SERVICE DEVICE INSTALLATION NTS

Other Work

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SEAL & SIGNATURE		
MARCUS		B
WOODS ENGINEE No. 62010689	:R	PRINCER T

MECHANICAL DETAILS


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PROJECT NORTH PROJECT No: 2407


DWG No:



M103

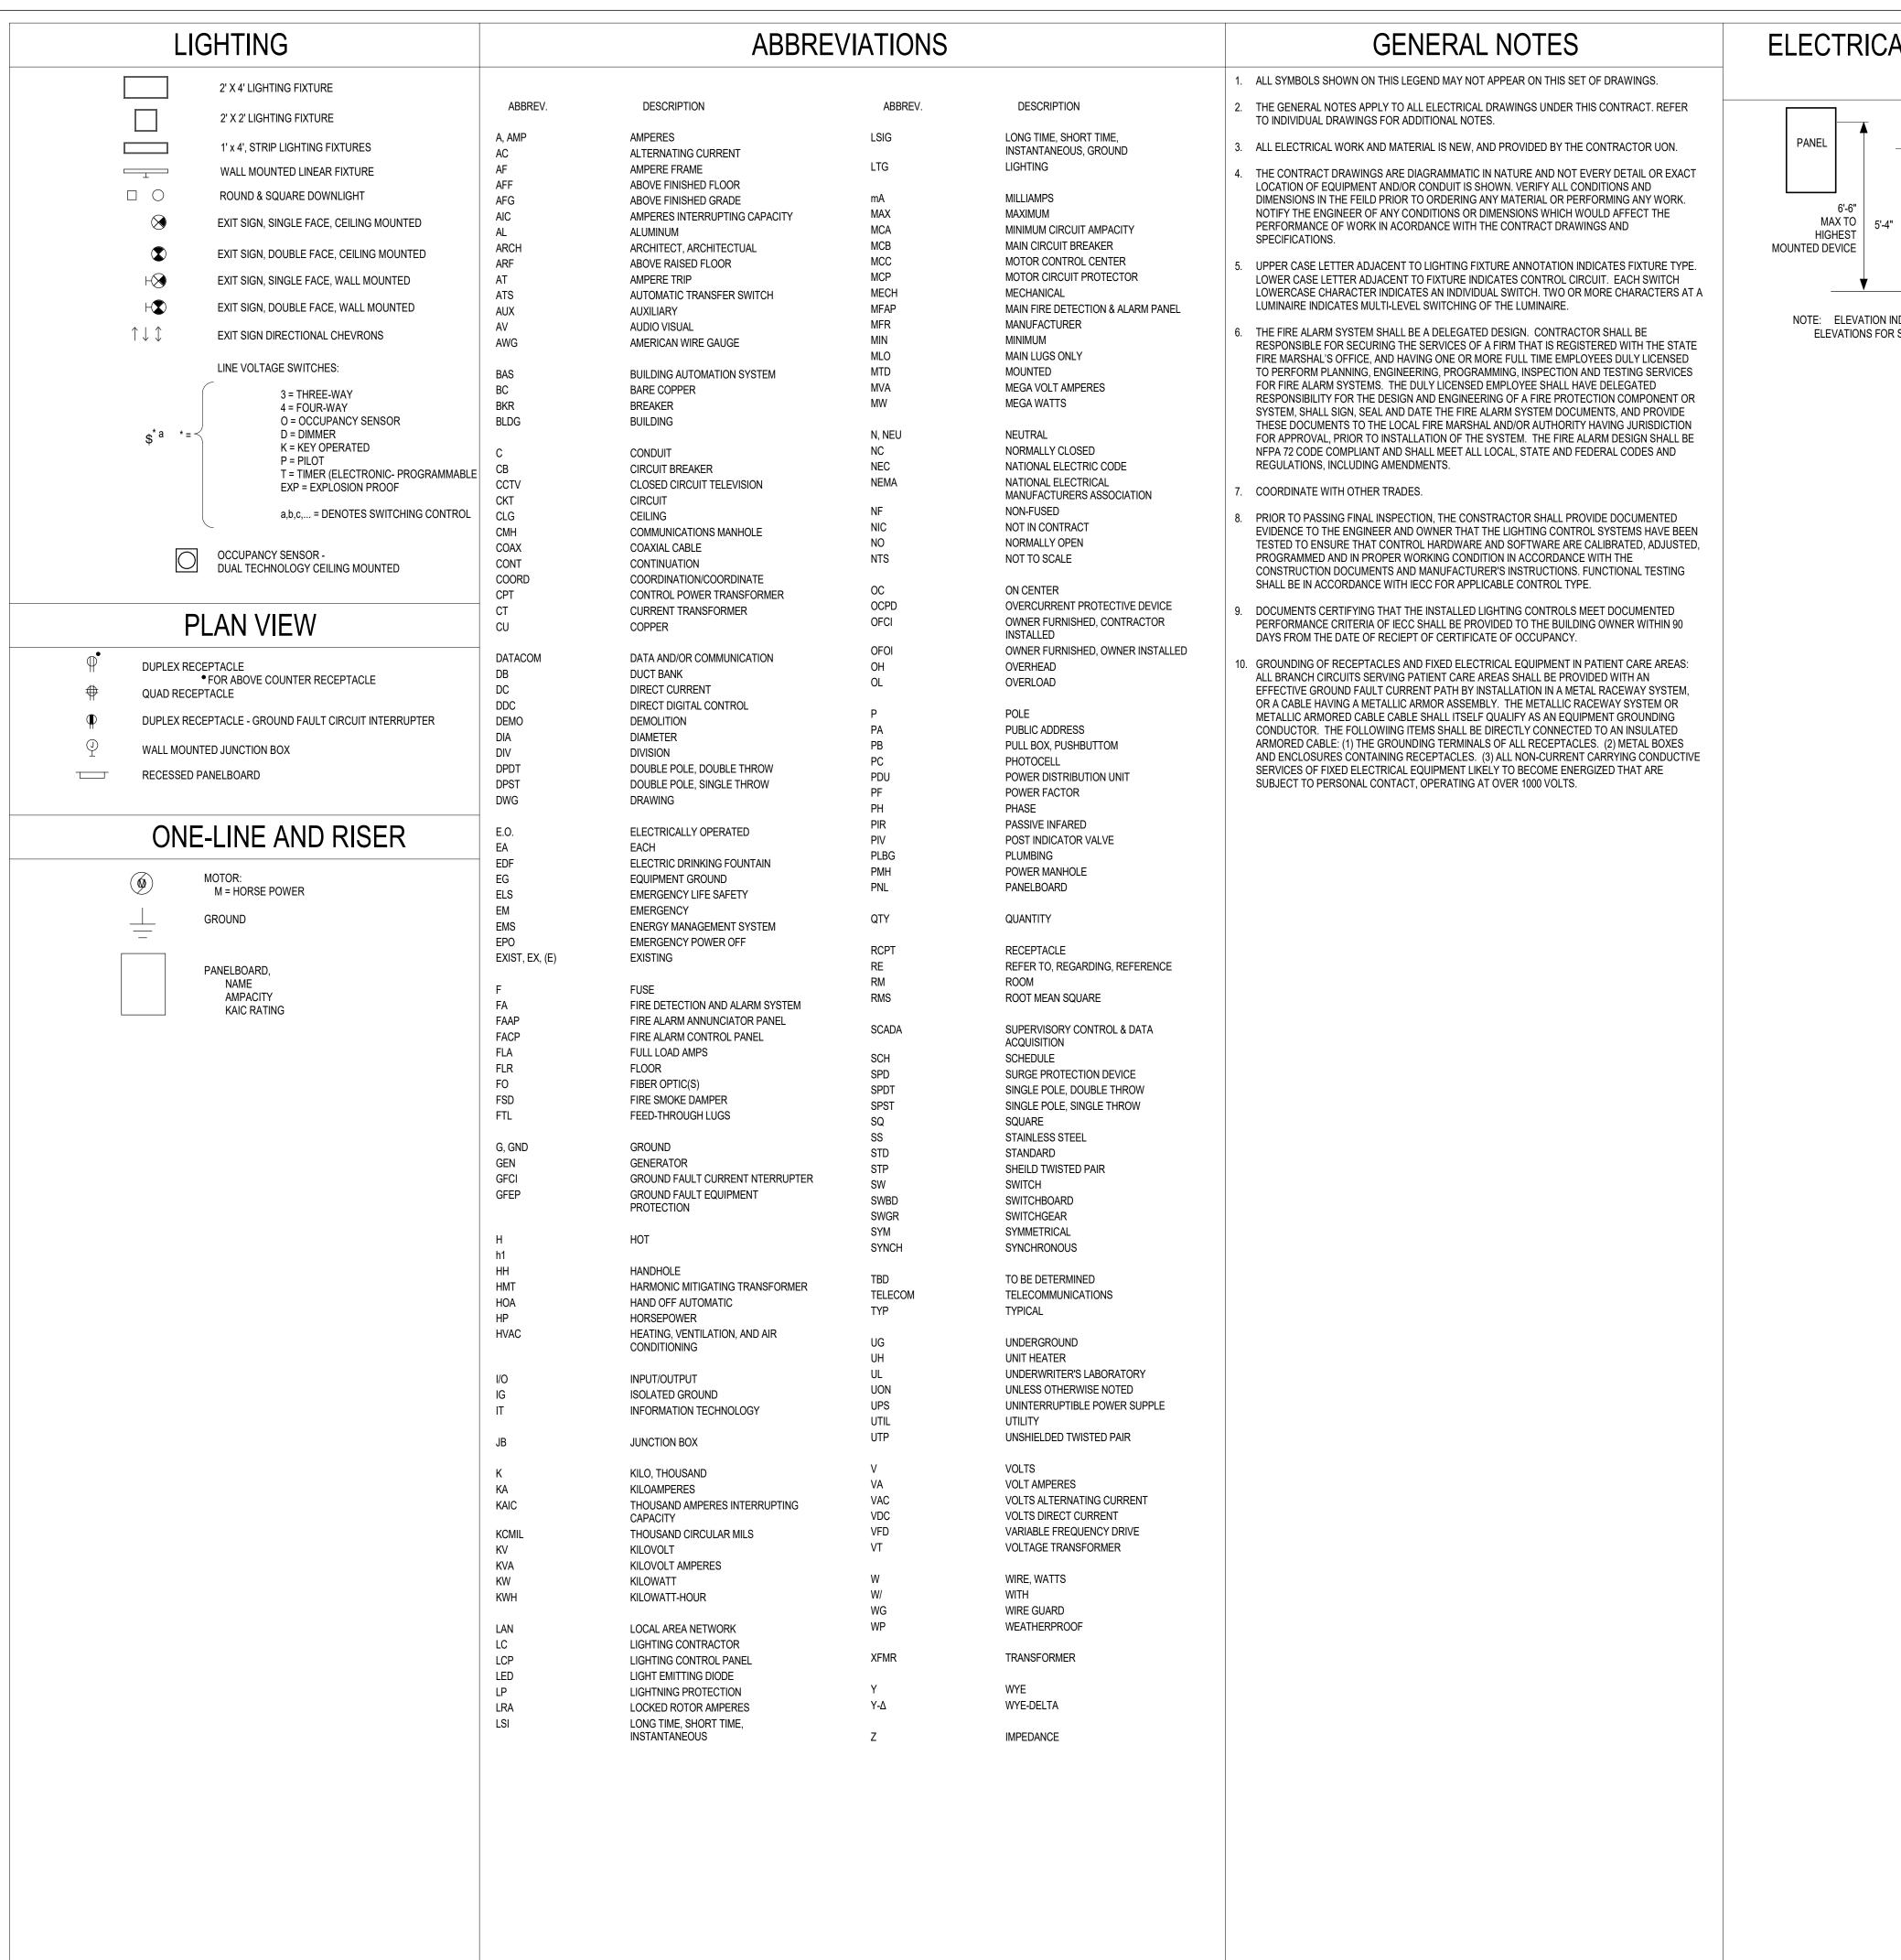

ELECTRICAL DEVICE MOUNTING HEIGHT

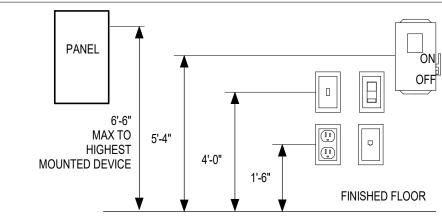

NOTE: ELEVATION INDICATED ARE TYPICAL; SEE ARCH DWGS AND ELEVATIONS FOR SPECIFIC DEVICE MOUNTING HEIGHTS.

Other Work

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PREPARED ON BEHALF OF:
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CONSTRUCTION DOCUMENTS		06NOV2024

SEAL & SIGNATURE



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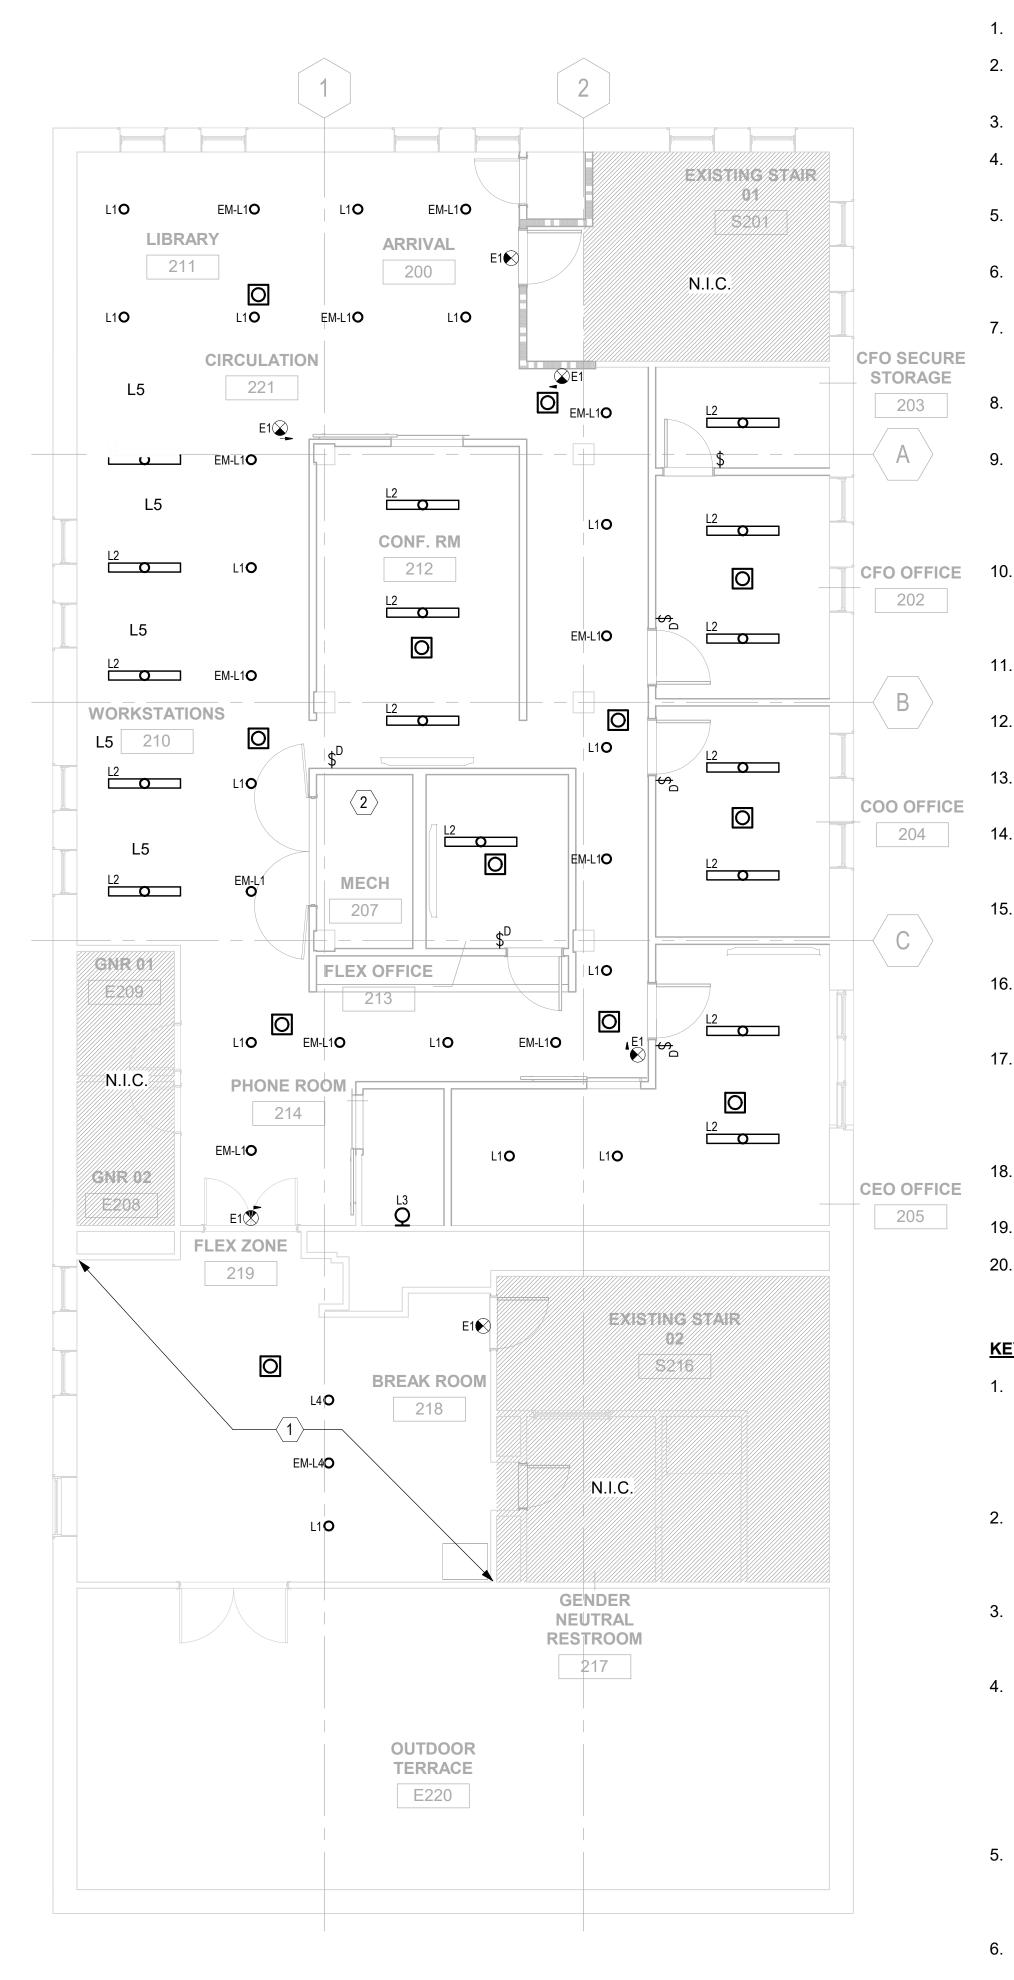
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ELECTRICAL LEGEND AND NOTES

PROJECT NORTH

PROJECT No: 2407 DWG No:

E001



GENERAL NOTES

- REFER TO DRAWING E001 FOR LEGEND, ABBREVIATIONS AND
- GENERAL NOTES. REFER TO ARCHITECTURAL DRAWINGS FOR ADDITIONAL INFORMATION REGARDING LUMINAIRE TYPE, MANUFACTURER
- INSTALLATION REQUIREMENTS AND NOTES. CONTRACTOR TO PROVIDE 80+ CRI, 35K AND 120V LED LUMINAIRES IN COORDINATION WITH ARCHITECT.
- COORDINATE FINAL LOCATION AND MOUNTING HEIGHT OF ALL SWITCHES, SENSORS AND OTHER LIGHTING DEVICES WITH ARCHITECT, PRIOR TO INSTALLATION.
- COORDINATE LOCATION OF EACH SWITCH CONTROLLING EACH LUMINAIRE AND LUMINAIRE ZONES WITH ARCHITECT AND
- FIELD COORDINATE FINAL LOCATION OF ALL EMERGENCY LIGHTING AND EXIT SIGNS WITH ARCHITECT AND OWNER PRIOR TO INSTALLATION.
- ALL LIGHTING TO BE POWERED VIA PANEL 'O', CIRCUIT 9. REFER TO PANEL SCHEDULE 'O' ON DRAWING E400 FOR ADDITIONAL INFORMATION REGARDING LIGHTING CIRCUIT BREAKER INFORMATION.
- COORDINATE FINAL LOCATION AND MOUNTING HEIGHT OF ALL RECEPTACLES AND DEVICES WITH ARCHITECT, PRIOR TO INSTALLATION.
- REFER TO MECHANICAL DRAWINGS FOR EQUIPMENT INFORMATION. REFER TO EQUIPMENT POWER CONNECTION SCHEDULES ON DRAWING E400 FOR ADDITIONAL ELECTRICAL POWER CONNECTION INFORMATION, FIELD VERIFY ALL EQUIPMENT MEETS MANUFACTURER REQUIREMENTS PRIOR TO INSTALLATION.
- FIELD COORDINATE FINAL LOCATION OF ALL SMOKE AND CARBON MONOXIDE DETECTORS WITH OWNER AND ARCHITECT. PROVIDE HARD-WIRE POWER CONNECTION TO ALL SMOKE AND CARBON MONOXIDE DETECTORS VIA EXISTING PANEL 'O',
- FIELD COORDINATE FINAL LOCATION ALL THERMOSTATS WITH MECHANICAL DRAWINGS AND ARCHITECT. HARD-WIRE ALL THERMOSTATS TO PANEL 'O', CIRCUIT 11.
- 12. REFER TO PANEL SCHEDULE 'O' ON DRAWING E400 FOR ADDITIONAL INFORMATION REGARDING CIRCUIT BREAKER INFORMATION.
- 13. MOUNT ABOVE COUNTER KITCHEN RECEPTACLES AT 48" AFF, COORDINATE FINAL MOUNTING HEIGHT AND LOCATION WITH ARCHITECT PRIOR TO INSTALLATION.
- 14. FIELD COORDINATE FINAL MOUNTING HEIGHT OF KITCHEN APPLIANCES WITH ARCHITECT AND PROVIDE POWER CONNECTION TO EACH EQUIPMENT IN ACCORDANCE WITH MANUFACTURER GUIDELINES.
- 15. PROVIDE EMERGENCY MINIMUM 90-MIN UL924 RATED BATTERY BACKUP FOR EXIT SIGN. FIELD COORDINATE FINAL LOCATION AND MOUNTING HEIGHT BASED ON EQUIPMENT AND DOOR LAYOUT.
- ALL EXISTING TO REMAIN SWITCHES AND RECEPTACLES NOT WITHIN SCOPE OF WORK ARE TO BE MAINTAINED AND REMAIN OPERATIONAL, UNLESS OTHERWISE DIRECTED BY OWNER AND ARCHITECT.
- CONTRACTOR TO FIELD VERIFY EMERGENCY LIGHTING MEETS 1 FOOT CANDLE MINIMUM REQUIREMENT AND EMERGENCY EGRESS PATHWAY LIGHTING MEETS 0.1 FOOT CANDLE MINIMUM REQUIREMENT IN ACCORDANCE WITH NFPA 101 GUIDELINES. PROVIDE EMERGENCY BATTERY BACKUP FOR ALL EMERGENCY LUMINAIRES.
- 18. EM DENOTED EMERGENCY LIGHTING, PROVIDE AND INSTALL EMERGENCY BATTERY BACK-UP FOR ALL LUMINAIRES WITH AN
- EM DESIGNATION. REFER TO DRAWING E400 FOR ADDITIONAL INFORMATION
- REGARDING EXISTING PANEL LOCATION AND SCHEDULE. 20. ALL ABOVE COUNTER RECEPTACLES TO BE 42" AFF. FIELD COORDINATION FINAL MOUNTING LOCATION WITH ARCHITECT AND OWNER PRIOR TO INSTALLATION.

KEYED NOTES

ELECTRICAL LIGHTING PLAN - LVL 02

SCALE: 3/16" = 1'-0"

- PROVIDE AND INSTALL ARCHITECTURAL LIGHTING THROUGHOUT FLEX AND BREAK ROOMS IN COORDINATION WITH ARCHITECT AND OWNER. ADDITIONALLY, PROVIDE AND INSTALL EMERGENCY EGRESS LIGHTING WITH EMERGENCY BATTERY BACKUP IN ACCORDANCE WITH NFPA GUIDELINES. FIELD COORDINATE LUMINAIRE LAYOUT WITH ARCHITECT PRIOR TO
- INSTALLATION. CONTRACTOR TO PROVIDE AND INSTALL BACK OF HOUSE PENDANT MOUNTED LED LIGHTING WITH EMERGENCY BATTERY BACKUP FOR MECHANICAL ROOM. PROVIDE LUMINAIRE INFORMATION TO ARCHITECT AND OWNER PRIOR TO INSTALLATION.
- PROVIDE WORKSTATION WITH POWER FOR FUTURE FURNITURE INSTALLATIONS. FIELD COORDINATE FINAL MOUNTING HEIGHT AND LOCATION WITH ARCHITECT AND OWNER PRIOR TO INSTALLATION.
- CONTRACTOR TO MAINTAIN AND VERIFY THE INTEGRITY OF ALL EQUIPMENT, WIRING AND ELECTRICAL COMPONENTS OF EXISTING FURNACE DURING RELOCATION AND AFTER REINSTALLATION. CONTRACTOR TO PROVIDE OWNER WRITTEN CONFIRMATION THAT FURNACE AND ALL ITS ELECTRICAL COMPONENTS, WIRING AND DISCONNECT SWITCHING ARE UNDAMAGED AND FULLY OPERATIONAL AFTER REINSTALLATION. CONTRACTOR TO PROVIDE POWER TO EXISTING FURNACE VIA EXISTING TO REMAIN CIRCUIT ON PANEL 'O'.
- INSTALL CU-1 ON ROOF, FIELD COORDINATE FINAL LOCATION WITH MECHANICAL DRAWINGS. REMOVE EXISTING CU-1 AND ITS ASSOCIATED WIRING AND BREAKER IN ACCORDANCE WITH NEC GUIDELINES. TAG SHOWN FOR COORDINATION PURPOSES
- INSTALL CU-2 ON ROOF, FIELD COORDINATE FINAL LOCATION WITH MECHANICAL DRAWINGS. TAG SHOWN FOR COORDINATION PURPOSES ONLY.

Other Work

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ELECTRICAL LVL 02 FLOOR PLANS


PROJECT NORTH

PROJECT No: 2407 DWG No:

E100



ELECTRICAL POWER PLAN - LVL 02 SCALE: 3/16" = 1'-0"

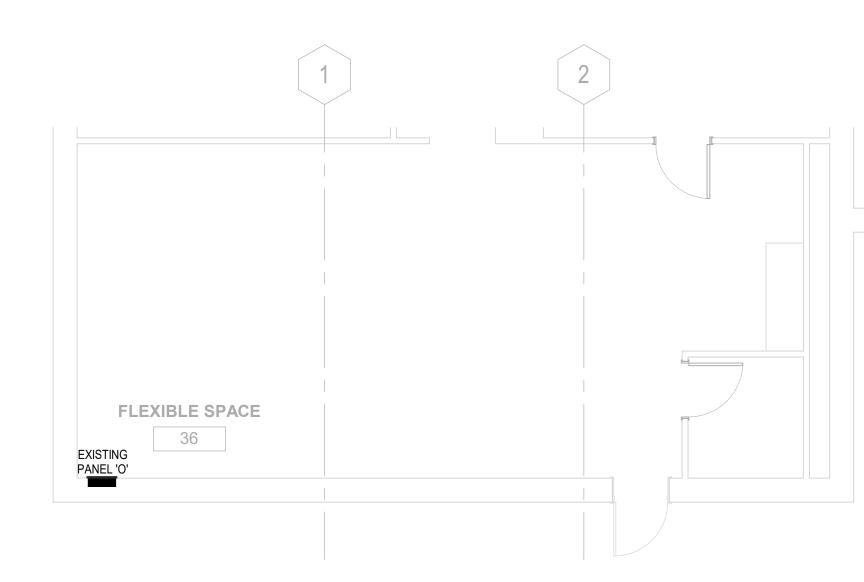

O (EXISTING TO REMAIN PANEL)

1	ELECTRICAL PARTIAL POWER PLAN - LVL 01 SCALE: 3/16" = 1'-0"
1)	SCALE: 3/16" = 1'-0"

PANEL NAME:

GENERAL NOTES

- 1. REFER TO DRAWING E001 FOR LEGEND, ABBREVIATIONS AND GENERAL NOTES.
- 2. EXITING PANEL 'O' SERVING SECOND LVL TO REMAIN AND BE MAINTAINED.
- 3. CONTRACTOR TO FIELD VERIFY AND TEST PANEL 'O' FOR AVAILABLE SPARE CAPACITY AND INSTALL NEW DESIGN BASED ON DRAWING E100 ACCORDINGLY.
- 4. CONTRACTOR TO FIELD VERIFY LOCATION, EQUIPMENT AND DEVICES THAT ARE BEING SERVED BY ALL EXISTING TO REMAIN CIRCUIT BREAKERS IN PANEL 'O'. FIELD VERIFY INTEGRITY OF ALL EXISTING TO BE MAINTAINED CIRCUIT BREAKERS AND WIRING AND REPLACE IN KIND IF DAMAGED.
- 5. CONTRACTOR TO PROVIDE OWNER WITH UPDATED PANEL SCHEDULE.
- CONTRACTOR TO FIELD VERIFY AND CONFIRM PANEL VOLTAGE OF 120/208V, 1 PHASE. SHOULD THERE BE ANY DISCREPANCIES, CONTRACTOR TO NOTIFY OWNER AND ARCHITECT IMMEDIATELY.
- 7. CONTRACTOR TO MAINTAIN ALL EXISTING TO REMAIN PANELS AS OPERATIONAL AND CONFIRM IN WRITING NO DAMAGE IS DONE DURING CONSTRUCTION.
- 8. PROVIDE AND INSTALL GFCI BREAKERS FOR ALL BREAKERS PROVIDING POWER TO GFCI RECEPTACLES. REFER TO DRAWING E100 FOR ADDITIONAL INFORMATION.

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PROJECT NAME: 2636 W HURON ST					PANEL VOLTAGE:				08V			AIC RATING: 4200		0
PANEL MOUNTING: FLUSH				PHASES:				1PHASE				MAINS TYPE: MCB		3
		WIRES:				3				MAINS RATING: 200A				
CKT	CIRCUIT	DESCRIPTION	LOAD TYPE	TRIP	POLES	VA	PHASE	VA	POLES	TRIP	LOAD TYPE	CIRCUIT DESCRIPTION	NC	Ck
1	EXISTING TO REMAIN BREAKER R		20	1		Α		1	20	R	EXISTING TO REMAIN BR	EAKER	2	
3	EXISTING TO REMAIN BREAKER R		R	20	1		В		1	20	R	EXISTING TO REMAIN BR	EAKER	4
5	EXISTING TO REMAIN BREAKER R			20	1		А		1	20	R	EXISTING TO REMAIN BR	EAKER	6
7	EXISTING TO REMAIN BREAKER R			20	1		В		1	20	R	EXISTING TO REMAIN BR	EAKER	8
9	LTG L			20	1	1000	Α		1	20	R	EXISTING TO REMAIN BR	EAKER	1
11	,	ERMOSTAT,TEF-1	Н	20	1	750	В		1	20	R	EXISTING TO REMAIN BR		1
13		C - MECH	R	20	1	360	Α		1	20	R	EXISTING TO REMAIN BR	EAKER	1
15	REC - CIRCULATION R		R	20	1	1080	В	1080	1	20	R	REC - ARRIVAL		1
17		NFERENCE RM	R	20	1	1080	Α	1080	1	20	R	REC - FLEX OFFICE		
19		CFO OFFICE	R	20	1	1080	В	1080	1	20	R	REC - COO OFFICE		2
21		CEO OFFICE	R	20	1	1080	Α	400	1	20	R	J BOX - WORKSTATIC		2
23	J BOX - W	ORKSTTAIONS	R	20	1	400	В	1080	1	20	R	REC - CONVENIENC	E	1
25	REC - CO	ONVENIENCE	R	20	1	1080	Α	400	1	20	R	REC - PRINTER		2
27	REC	- PRINTER	R	20	1	400	В	1080	1	20	R	REC - COE OFFICE	-	2
29	REC -	FLEX ZONE	R	20	1	1080	Α	540	1	20	R	REC - BREAK RM		3
31	REC -	BREAK RM	R	20	1	1080	В	1200	1	20	R	REC - FRIDGE		3
33	REC -	- GRIDDLE	R	20	1	540	Α	800	1	20	R	J BOX - GARBAGE DISP	OSAL	3
35	J BOX - [DISHWASHER	R	20	1	1400	В	2600	2	40	ML	CU-1		3
37		F-2	Н	15	1	1400	Α	2600		40	ML			3
39	ERV-1		Н	H 45	2	1155	В	2340	2 35	25	Н	CU-2		_
41			Н	15		1155	Α	2340		ან	Н			_

	MECHANICAL EQUIPMENT								
NAME	NUMBER	DESCRIPTION	VOLTAGE	PHASE	WATTAGE	PANEL	CIRCUIT NUMBER	NOTES	
(E) F	1	EXISTING FURNACE	120	1	-	PANEL 'O'	_	COORDINATE FINAL LOCATION WITH MECHANICAL DRAWINGS. FIELD COORDINATE POWER CONNECTION WITH MANUFACTURER GUIDELINES.	
F	2	FURNACE	120	1	1400	PANEL 'O'	37	COORDINATE FINAL LOCATION WITH MECHANICAL DRAWINGS. FIELD COORDINATE POWER CONNECTION WITH MANUFACTURER GUIDELINES.	
CU	1*	CONDENSING UNIT	208	1	5200	PANEL 'O'	1 36.38	COORDINATE FINAL LOCATION WITH MECHANICAL DRAWINGS. FIELD COORDINATE POWER CONNECTION WITH MANUFACTURER GUIDELINES.	
CU	2**	CONDENSING UNIT	208	1	4680	PANEL 'O'	1 40.42	COORDINATE FINAL LOCATION WITH MECHANICAL DRAWINGS. FIELD COORDINATE POWER CONNECTION WITH MANUFACTURER GUIDELINES.	
ERV	1	ENERGY RECOVERY UNIT	208	1	2310	PANEL 'O'	I 39.41	COORDINATE FINAL LOCATION WITH MECHANICAL DRAWINGS. FIELD COORDINATE POWER CONNECTION WITH MANUFACTURER GUIDELINES.	
TEF	1	TOILET EXHAUST FAN	120	1	12	PANEL 'O'	1 11	COORDINATE FINAL LOCATION WITH MECHANICAL DRAWINGS. FIELD COORDINATE POWER CONNECTION WITH MANUFACTURER GUIDELINES.	

- * FIELD COORDINATE FINAL LOCATION ON ROOF WITH ARCHITECT AND OWNER. PROVIDE POWER TO NEW CU-1 IN ACCORDANCE WITH MANUFACTURER GUIDELINES AND MECHANICAL DRAWINGS. REMOVE EXISTING CU-1 AND ALL ITS ASSOCIATED WIRING IN ACCORDANCE WITH NEC GUIDELINES.
- ** FIELD COORDINATE FINAL LOCATION ON ROOF WITH ARCHITECT AND OWNER. PROVIDE POWER TO NEW CU-2 IN ACCORDANCE WITH MANUFACTURER GUIDELINES AND MECHANICAL DRAWINGS.

Other Work

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ELECTRICAL RISER AND SCHEDULES

PROJECT NORTH

PROJECT No: 2407

DWG No:



E400